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GENERAL NOTES:

THIS PLAN SET, COMBINED WITH THE BUILDING CONTRACT, PROVIDES BUILDING DETAILS FOR THE RESIDENTIAL PROJECT. THE CONTRACTOR SHALL VERIFY THAT SITE CONDITIONS ARE CONSISTENT WITH THESE PLANS BEFORE STARTING WORK. WORK NOT SPECIFICALLY DETAILED SHALL BE CONSTRUCTED TO THE SAME QUALITY AS SIMILAR WORK THAT IS DETAILED. ALL WORK SHALL BE DONE IN ACCORDANCE WITH INTERNATIONAL BUILDING CODES AND LOCAL CODES. CONTRACTOR SHALL BE RESPONSIBLE AND BEAR ANY FINES OR PENALTIES FOR CODE, ORDINANCE, REGULATION OR BUILDING PROCESS VIOLATIONS. INSURANCES SHALL BE IN FORCE THROUGHOUT THE DURATION OF THE BUILDING PROJECT.

WRITTEN DIMENSIONS AND SPECIFIC NOTES SHALL TAKE PRECEDENCE OVER SCALED DIMENSIONS AND GENERAL NOTES. THE ENGINEER/DESIGNER SHALL BE CONSULTED FOR CLARIFICATION IF SITE CONDITIONS ARE ENCOUNTERED THAT ARE DIFFERENT THAN SHOWN, IF DISCREPANCIES ARE FOUND IN THE PLANS OR NOTES, OR IF A QUESTION ARISES OVER THE INTENT OF THE PLANS OR NOTES. CONTRACTOR SHALL VERIFY AND IS RESPONSIBLE FOR ALL DIMENSIONS (INCLUDING ROUGH OPENINGS).

ALL TRADES SHALL MAINTAIN A CLEAN WORK SITE AT THE END OF EACH WORK DAY.

PLEASE SEE ADDITIONAL NOTES CALLED OUT ON OTHER SHEETS.

OWNER: HOUSE FOR HOMESTM

PROJECT: 1910 E. GRANDVIEW DR. ADDRESS: COEUR D'ALENE, IDAHO

LEGAL: LOT 7, BLK 1

MOODLAND HEIGHTS SEVENTH ADDITION

FIRE DISTRICT KOOTENAI FIRE & RESCUE MATER: NORTH KOOTENAI WATER SEMER: HAYDEN LAKE RECREATIONAL SEWER

STORM WATER PERMIT: RETAINING WALL PERMIT: BUILDING PERMIT:

SDP16-0202 RES17-0060 RES16-1330

DESIGNER: DESIGN CONSULTANT: BUILDER: SITE DISTURBANCE: ENGINEERING:


CHIEF ARCHITECT H2A ARCHITECTS YOUNG CONSTRUCTION CLEARWATER SUMMIT BC ENGINEERS

INDEX OF DRAWINGS SHEET PROJECT SUMMARY SITE & DISTURBANCE PLAN ROCKERY WALL DETAIL MAIN FLOOR PLAN 2ND FLOOR PLAN &STAIR SECTION FOUNDATION PLAN ELEVATIONS SECTIONS & DETAILS SECTIONS & DETAILS SHEAR WALL LOCATIONS MALL FRAMING FLOOR FRAMING 13 ROOF PLAN DOOR & MINDOM SCHEDULE INTERIOR ELEVATIONS ELECTRICAL PLAN PLUMBING &HYAC PLAN MSTR BATH PLAN & ELEVATIONS 18

KITCHEN PLAN & ELEVATIONS

TITLE



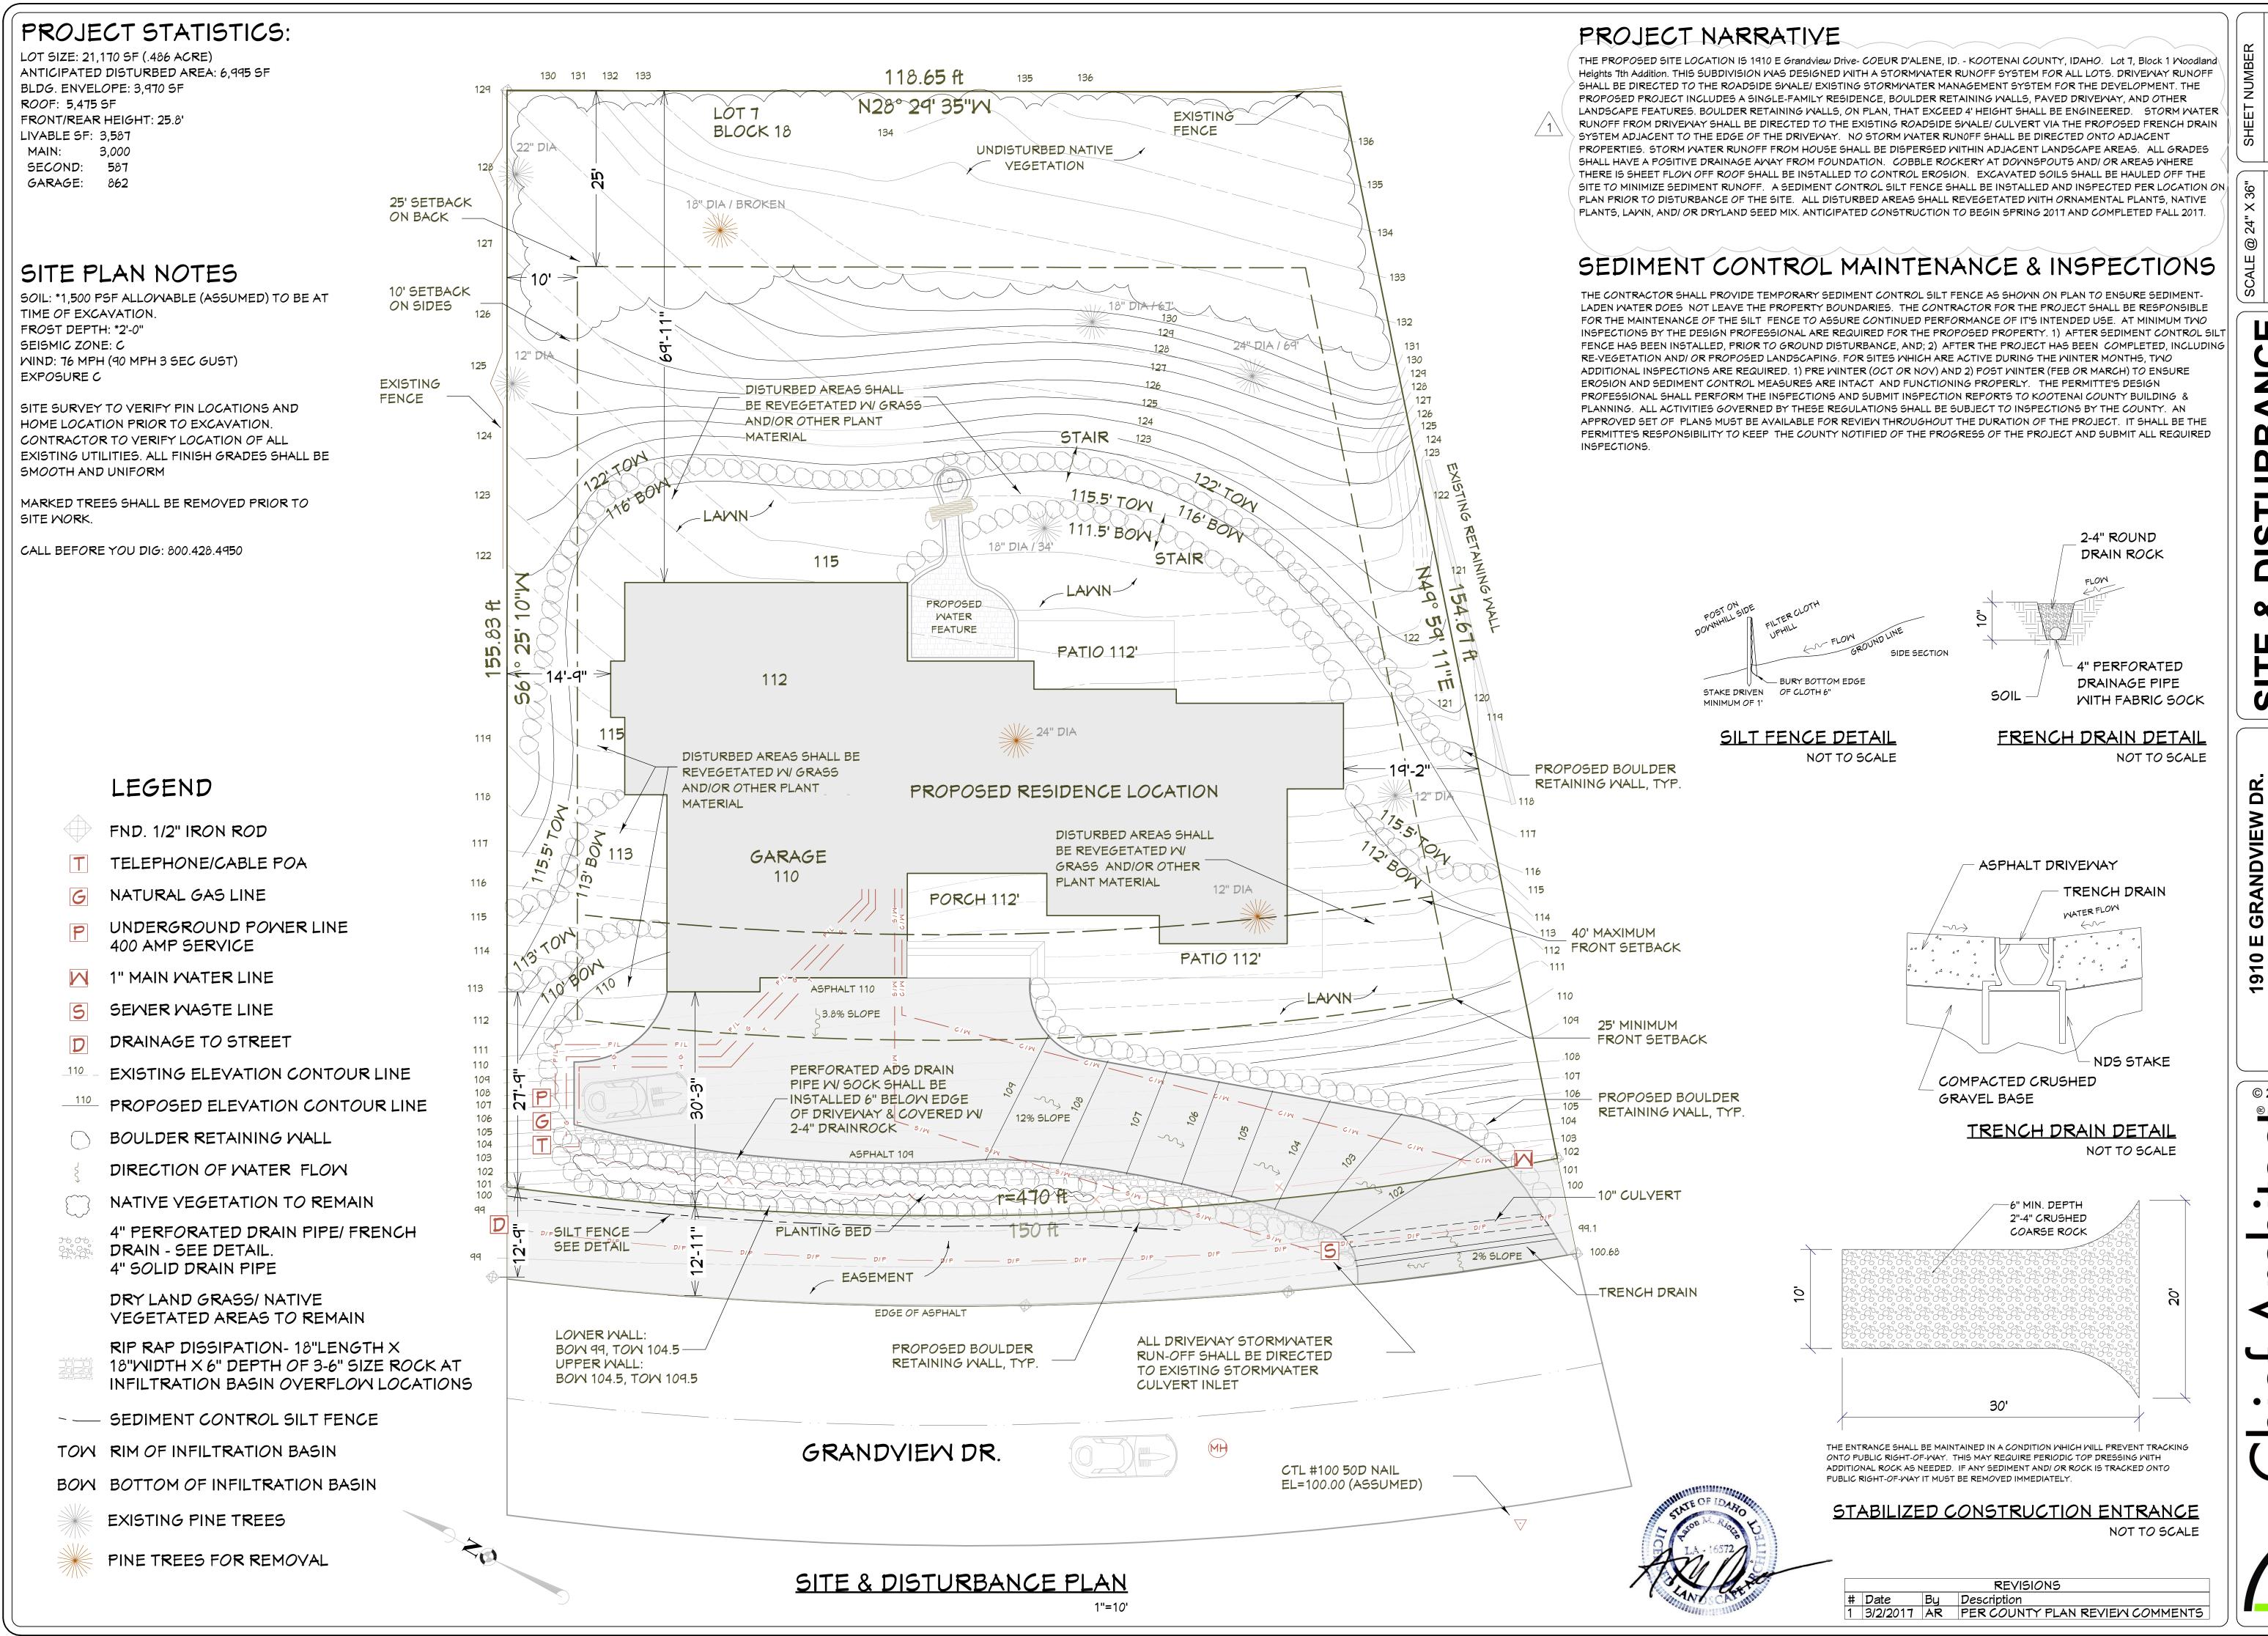

DRAWN BY: S.H. DATE:

A \mathbf{m} 8 SITE

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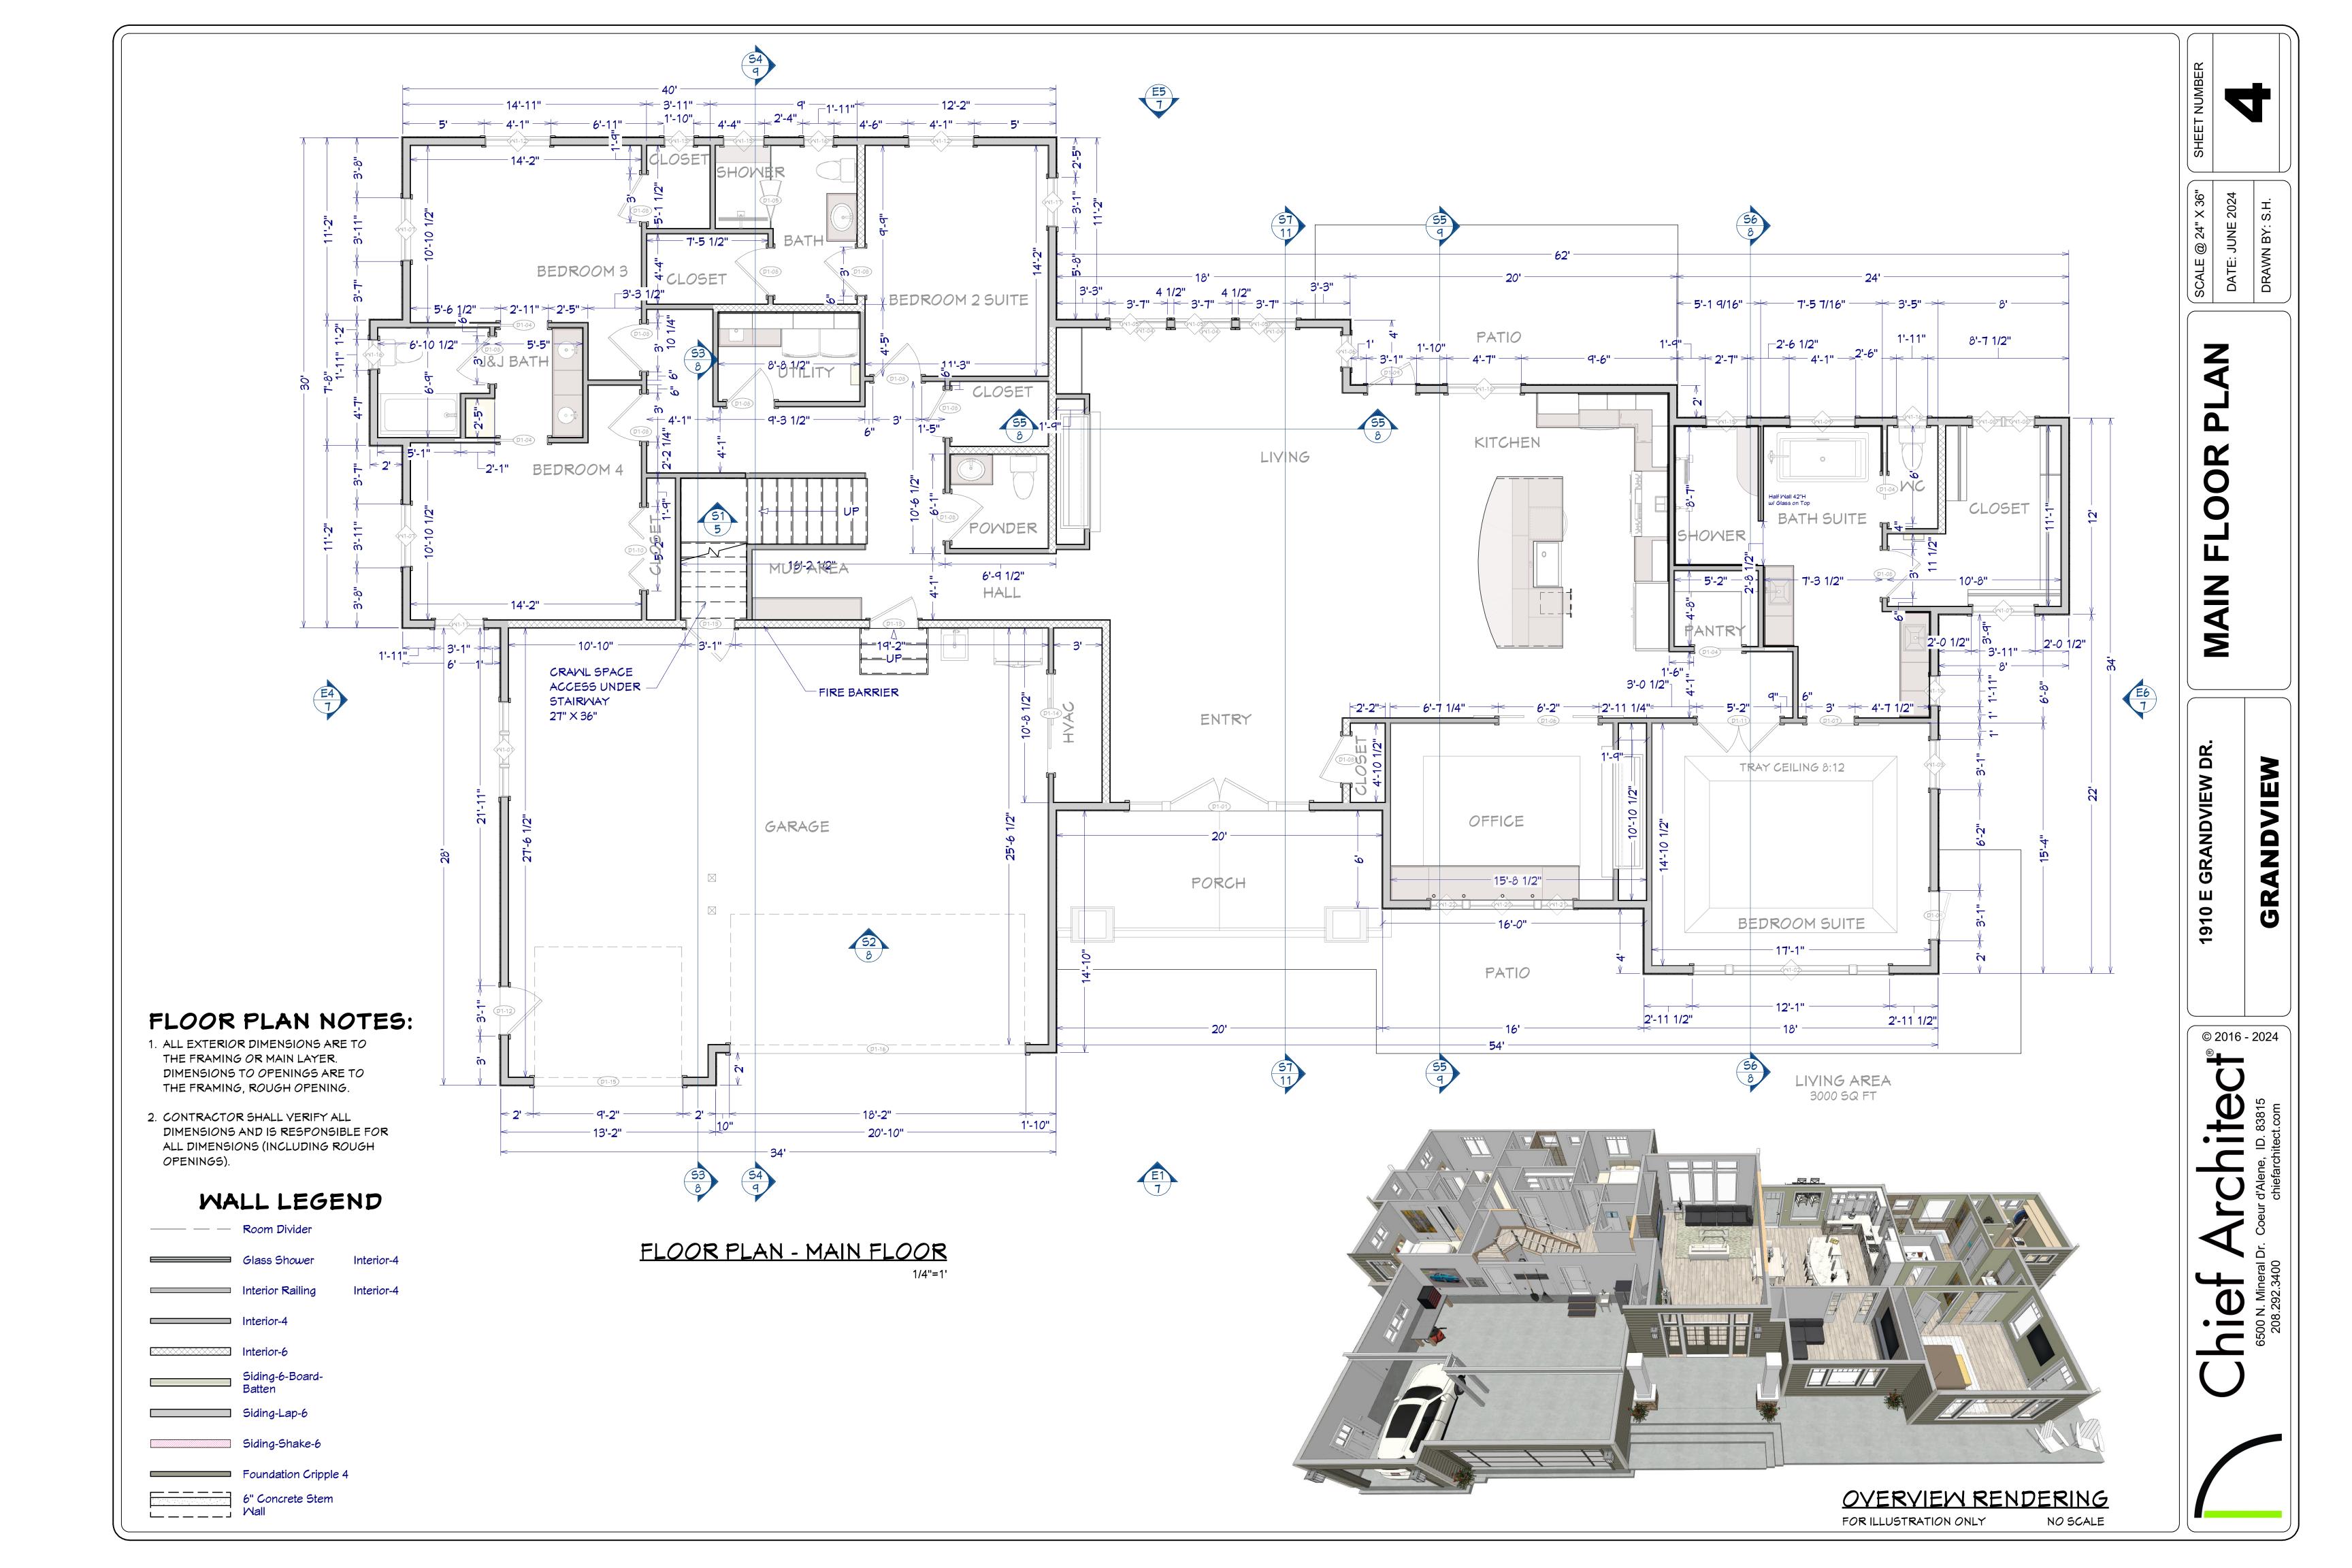
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ROCKERY ELEVATION

GRANDVIEW DR.

SITE PLAN

ROCKERY SCHEDULE



BUILDING PERFORMANCE:

- 1. HEAT LOSS CALCULATIONS SHALL COMPLY WITH REScheck AND/OR REQUIREMENTS OF LOCAL CODES.
- 2. PORCHES, DECKS, BALCONIES, FOUNDATION AND GARAGE AREAS NOT INCLUDED IN LIVING AREA.
- 3. ALL EXHAUST FANS TO BE VENTED DIRECTLY TO THE EXTERIOR. ALL PENETRATIONS OF THE BUILDING ENVELOPE SHALL BE SEALED WITH CAULK OR FOAM.
- 3. PROVIDE CRAWLSPACE VENTING TO MEET LOCAL CODE REQUIREMENTS INSULATE ALL ACCESS DOORS! HATCHES TO CRAWL SPACES AND ATTICS TO THE EQUIVALENT RATING OF THE WALL, FLOOR OR CEILING THROUGH WHICH THEY PENETRATE, UNO.
- 4. MINIMUM INSULATION:

ATTIC R-50 MALLS R-21 FLOORS R-38



Project Grandview

Energy Code: 2012 IECC
Location: Kootenai, Idaho
Construction Type: Single-family
Project Type: New Construction
Orientation: Bldg. faces 270 deg. from North
Conditioned Floor Area: 3,587 ft2
Glazing Area 18%

Climate Zone: **6 (7500 HDD)**Permit Date:

Construction Site: 1910 E Grandview Drive

Permit Number:

Owner/Agent:

Designer/Contractor:

Compliance: Passes using UA trade-off


Compliance: 3.5% Better Than Code Maximum UA: 574 Your UA: 554

The % Better or Worse Than Code Index reflects how close to compliance the house is based on code trade-off rules. It DOES NOT provide an estimate of energy use or cost relative to a minimum-code home.

INSPECTION NOTES:

- 1. PROVIDE SPECIAL INSPECTION, SPECIAL TESTING, REPORTING AND COMPLIANCE PROCEDURES ACCORDING TO THE LOCAL BUILDING CODE.
- 2. SPECIAL INSPECTOR QUALIFICATIONS: DEMONSTRATE COMPETENCE, TO THE SATISFACTION OF THE BUILDING OFFICIAL, FOR INSPECTION OF THE PARTICULAR TYPE OF CONSTRUCTION OR OPERATION IN QUESTION. PRIOR TO THE BEGINNING OF CONSTRUCTION, REVIEW THE SPECIAL INSPECTION REQUIREMENTS WITH THE ARCHITECT, ENGINEER, BUILDING OFFICIAL, GENERAL CONTRACTOR AND SPECIAL INSPECTORS. DUTIES OF THE SPECIAL INSPECTOR INCLUDE, BUT ARE NOT LIMITED TO:
- A. OBSERVE THE WORK FOR CONFORMANCE WITH THE APPROVED PERMIT DRAWINGS AND SPECIFICATIONS. BRING DISCREPANCIES TO THE IMMEDIATE ATTENTION OF THE CONTRACTOR FOR BUILDING OFFICIAL.
- B. FURNISH INSPECTION REPORTS FOR EACH INSPECTION TO THE BUILDING OFFICIAL, ARCHITECT, ENGINEER, GENERAL
- CONTRACTOR AND OWNER IN A TIMELY MANNER.


 C. SUBMIT A FINAL REPORT STATING WHETHER THE WORK
 REQUIRING SPECIAL INSPECTION WAS INSPECTED, AND WHETHER
 THE WORK IS IN CONFORMANCE WITH THE APPROVED PERMIT
 DRAWINGS AND SPECIFICATIONS.
- 3. DUTIES OF THE CONTRACTOR INCLUDE, BUT ARE NOT LIMITED TO:
- A. NOTIFY SPECIAL INSPECTOR THAT WORK IS READY FOR INSPECTION AT LEAST 24 HOURS BEFORE THE INSPECTION IS REQUIRED.
- B. MAINTAIN ACCESS TO WORK REQUIRING SPECIAL INSPECTION UNTIL IT HAS BEEN OBSERVED AND INDICATED TO BE IN CONFORMANCE BY THE SPECIAL INSPECTOR AND APPROVED BY THE BUILDING OFFICIAL.
- C. PROVIDE THE SPECIAL INSPECTOR WITH ACCESS TO APPROVED PERMIT DRAWINGS AND SPECIFICATIONS AT THE JOB SITE.
- D. MAINTAIN JOB-SITE COPIES OF ALL REPORTS SUBMITTED BY THE SPECIAL INSPECTOR.

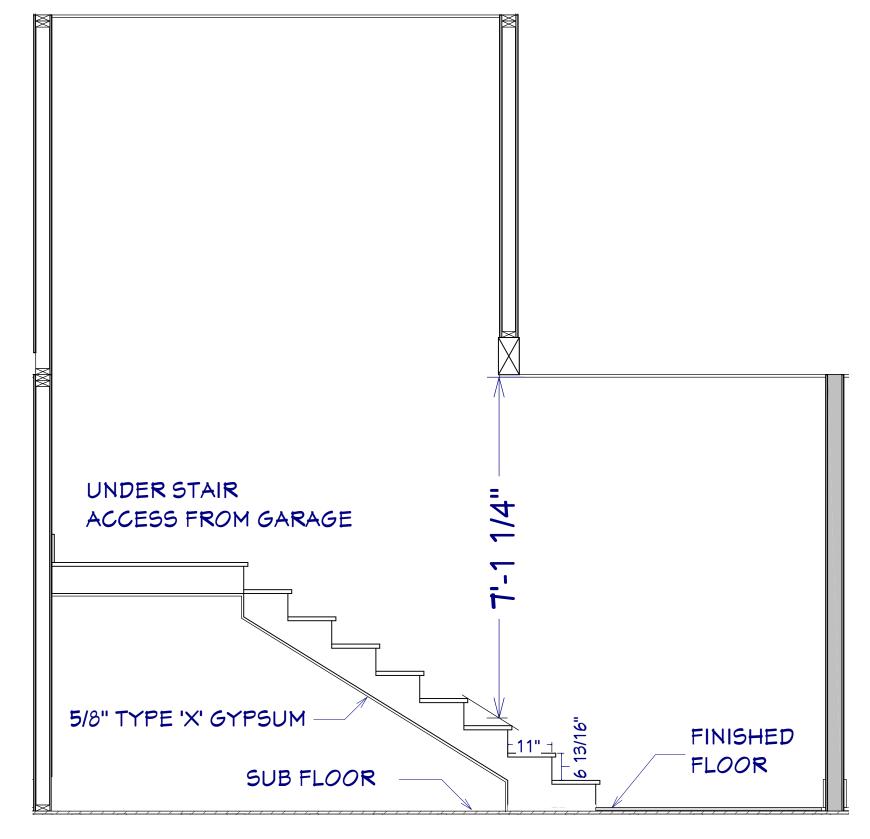



STAIR NOTES:

- 1STAIRWAYS SHALL HAVE A MIN. WIDTH OF 34". HAND RAILS MAY ENCROACH A MAX. OF 3 1/2" INTO THE
- 2TREADS SHALL HAVE A MIN. WIDTH OF 10". STAIR TREADS MUST BE UNIFORM AND CAN NOT VARY FROM THE LARGEST TO THE SMALLEST BY MORE THAN 3/8".
- 3STAIRWAYS SHALL HAVE MIN. 6'-8" OF HEADROOM AT THE NOSE OF THE STAIR.
- 4ENCLOSED USABLE SPACE UNDER INTERIOR STAIRS SHALL BE PROTECTED ON THE ENCLOSED FACE WITH 5/8" TYPE "X" GYPSUM WALL BOARD.
- 5STAIRWAYS SHALL HAVE AT LEAST ONE HANDRAIL LOCATED 36" ABOVE THE NOSING OF TREADS AND LANDINGS. THE HAND GRIP PORTION OF HANDRAILS SHALL NOT BE LESS THAN 1-1/2" OR GREATER THAN 2" IN CROSS-SECTIONAL DIMENSION.
- 6HANDRAILS SHALL BE CONTINUOUS THE FULL LENGTH OF THE STAIRS. THE ENDS OF HANDRAILS SHALL
- RETURN TO WALL OR TERMINATE INTO A NEWEL POST OR SAFETY TERMINAL.
- 7STAIRWAYS HAVING LESS THAN 2 RISERS DO NOT REQUIRE A HAND RAIL.
- 8GUARDRAILS SHALL BE PROVIDED FOR AT PORCHES, DECKS, BALCONIES, STAIRWAYS AND LANDINGS WHERE
- THE ADJACENT SURFACE IS GREATER THAN 24" BELOW AND SHALL HAVE A 34" MIN. HEIGHT
- PRAILING AND GUARDRAIL BALUSTER SPACING SHALL BE NO GREATER THAN 4".
- 10HE TRIANGULAR OPENINGS FORMED BY THE RISER, TREAD, AND BOTTOM OF GUARDRAIL SHALL NOT ALLOW A 6" DIAMETER SPHERE TO PASS THROUGH.

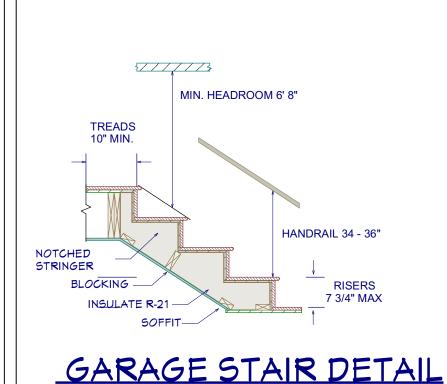



NO SCALE



STAIR RENDERING
NO SCALE

10'-8 1/2" - 13'-3 1/2" OPEN TO -+DN---ENTERTAINMENT 2'-7 1/2" 1'-2 1/2" 12'-8 1/2" BALCONY LIVING AREA 587 SQ FT FLOOR PLAN - FLOOR 2



OVERVIEW RENDERING
FOR ILLUSTRATION ONLY
NO SCALE

HEET NOMBER

TE: JUNE 2024
AWN BY: S.H.

DATE: JU

AD FLOOR PLAN 8


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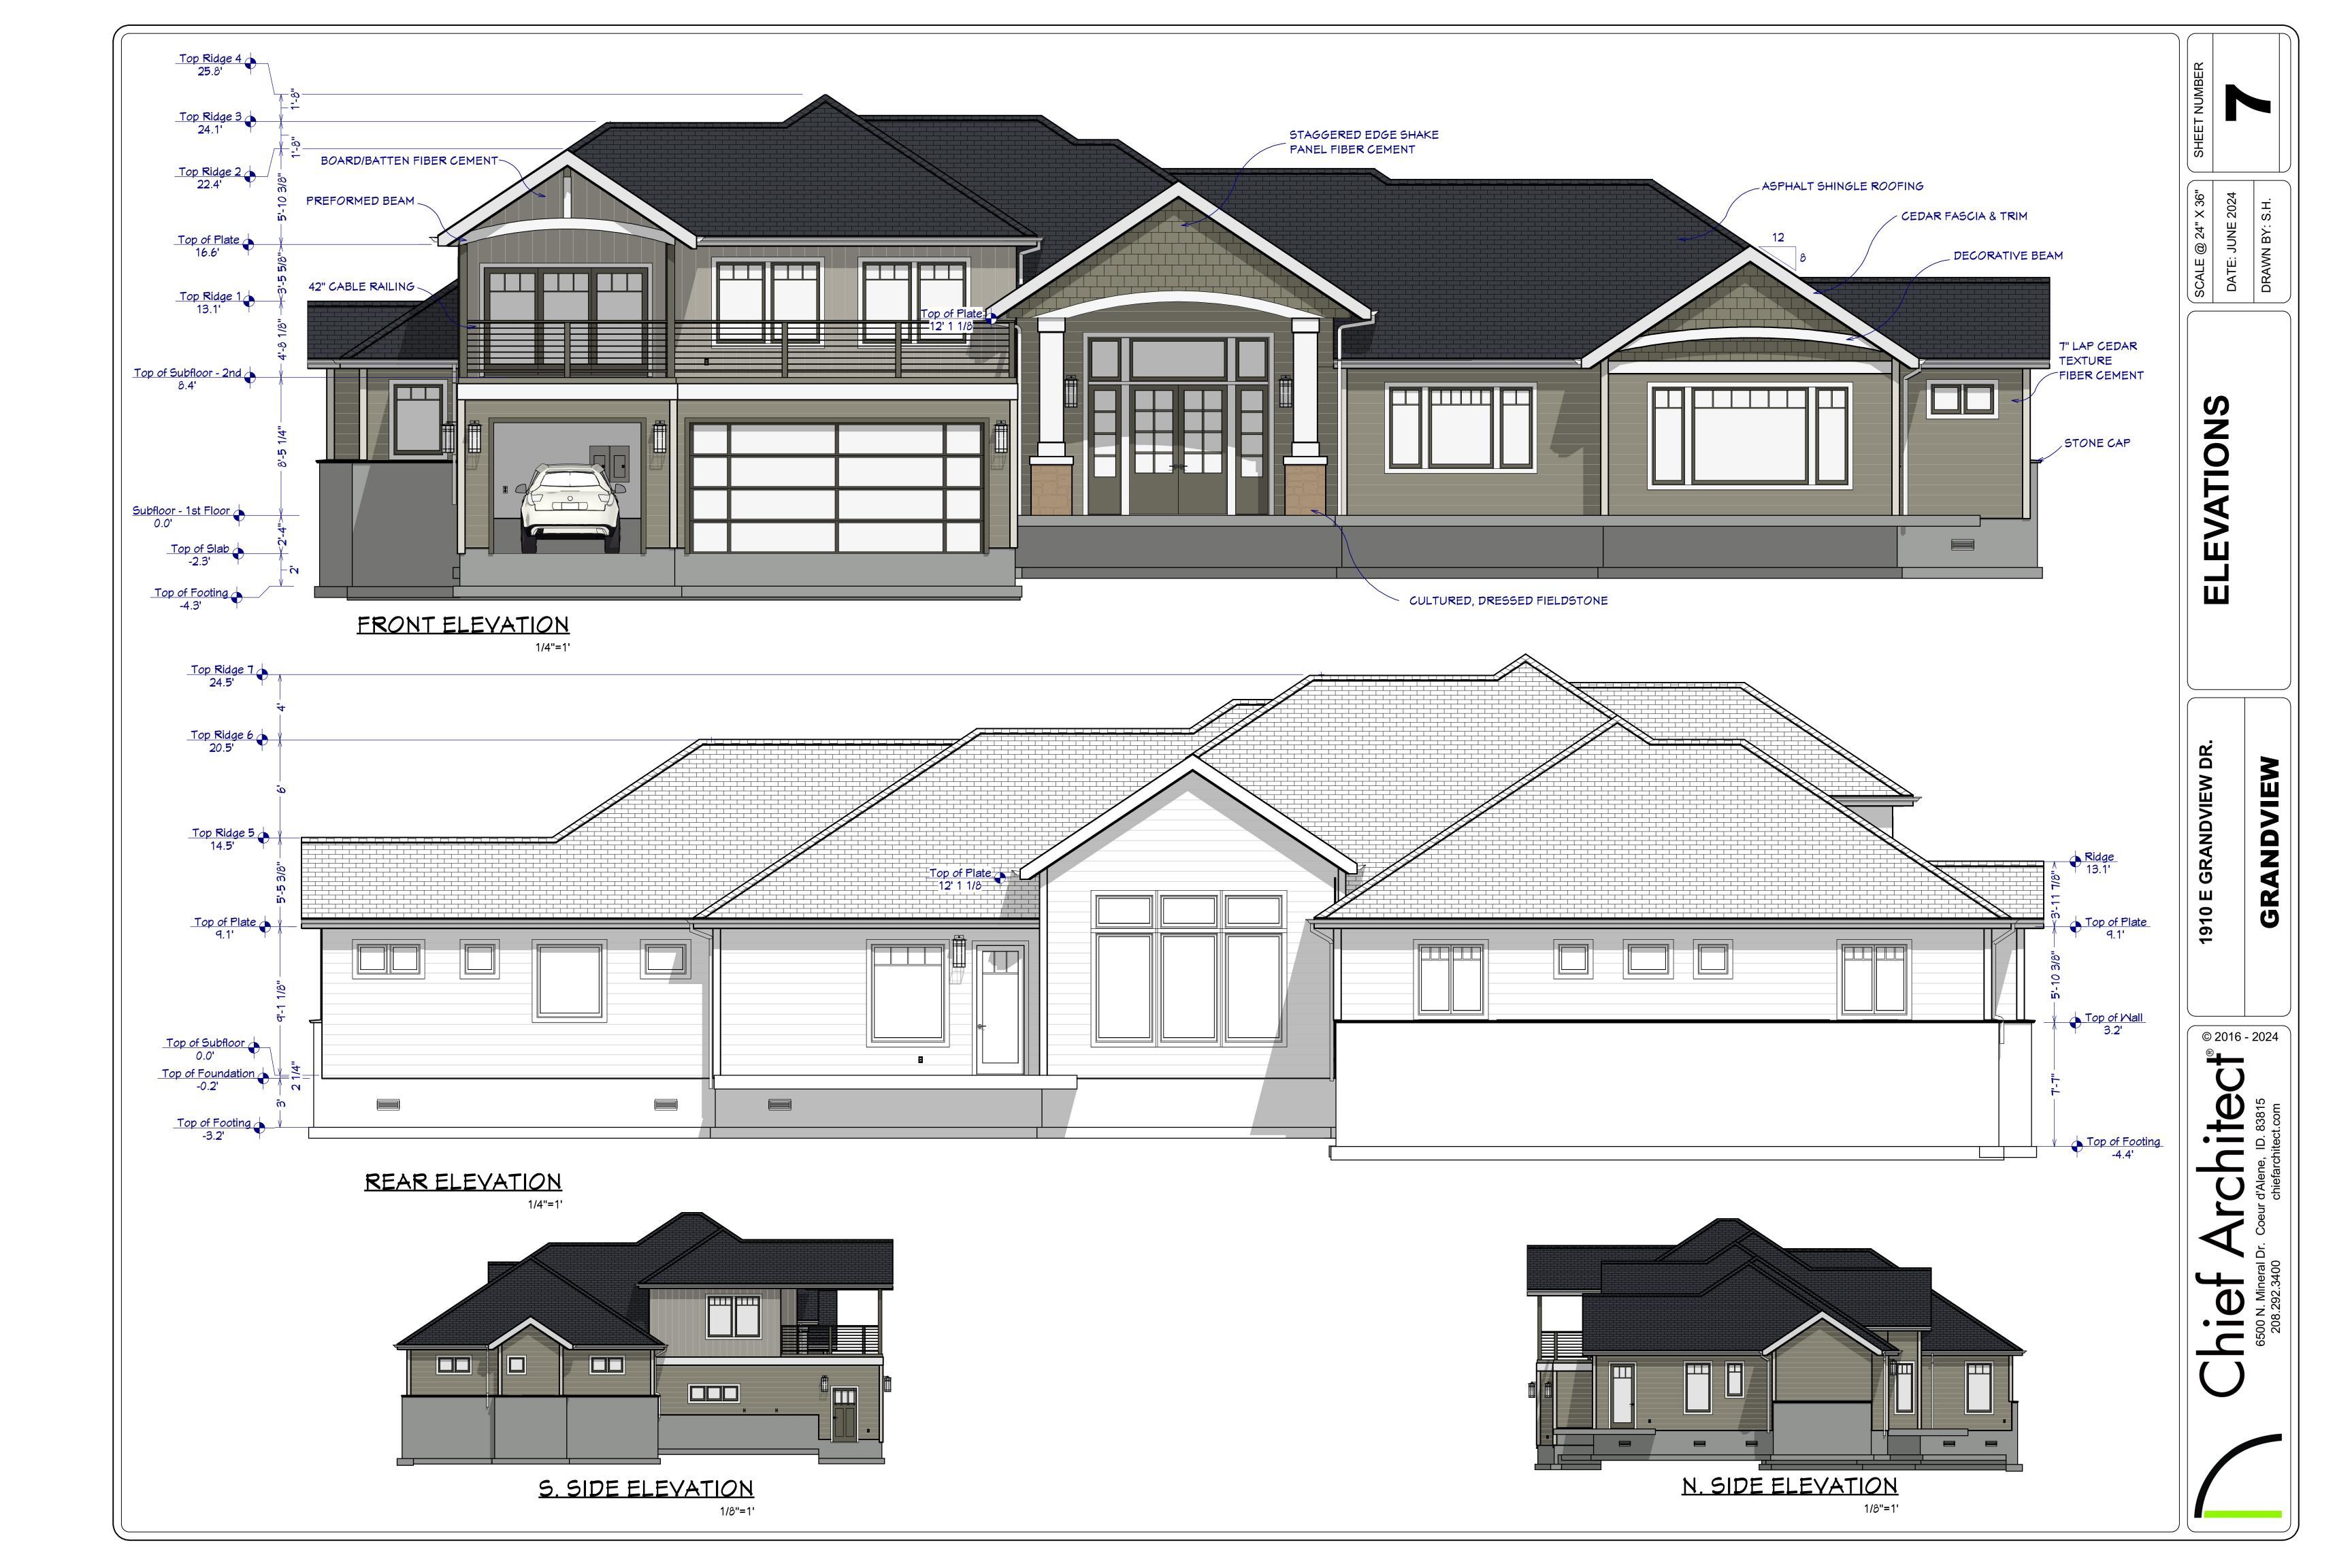
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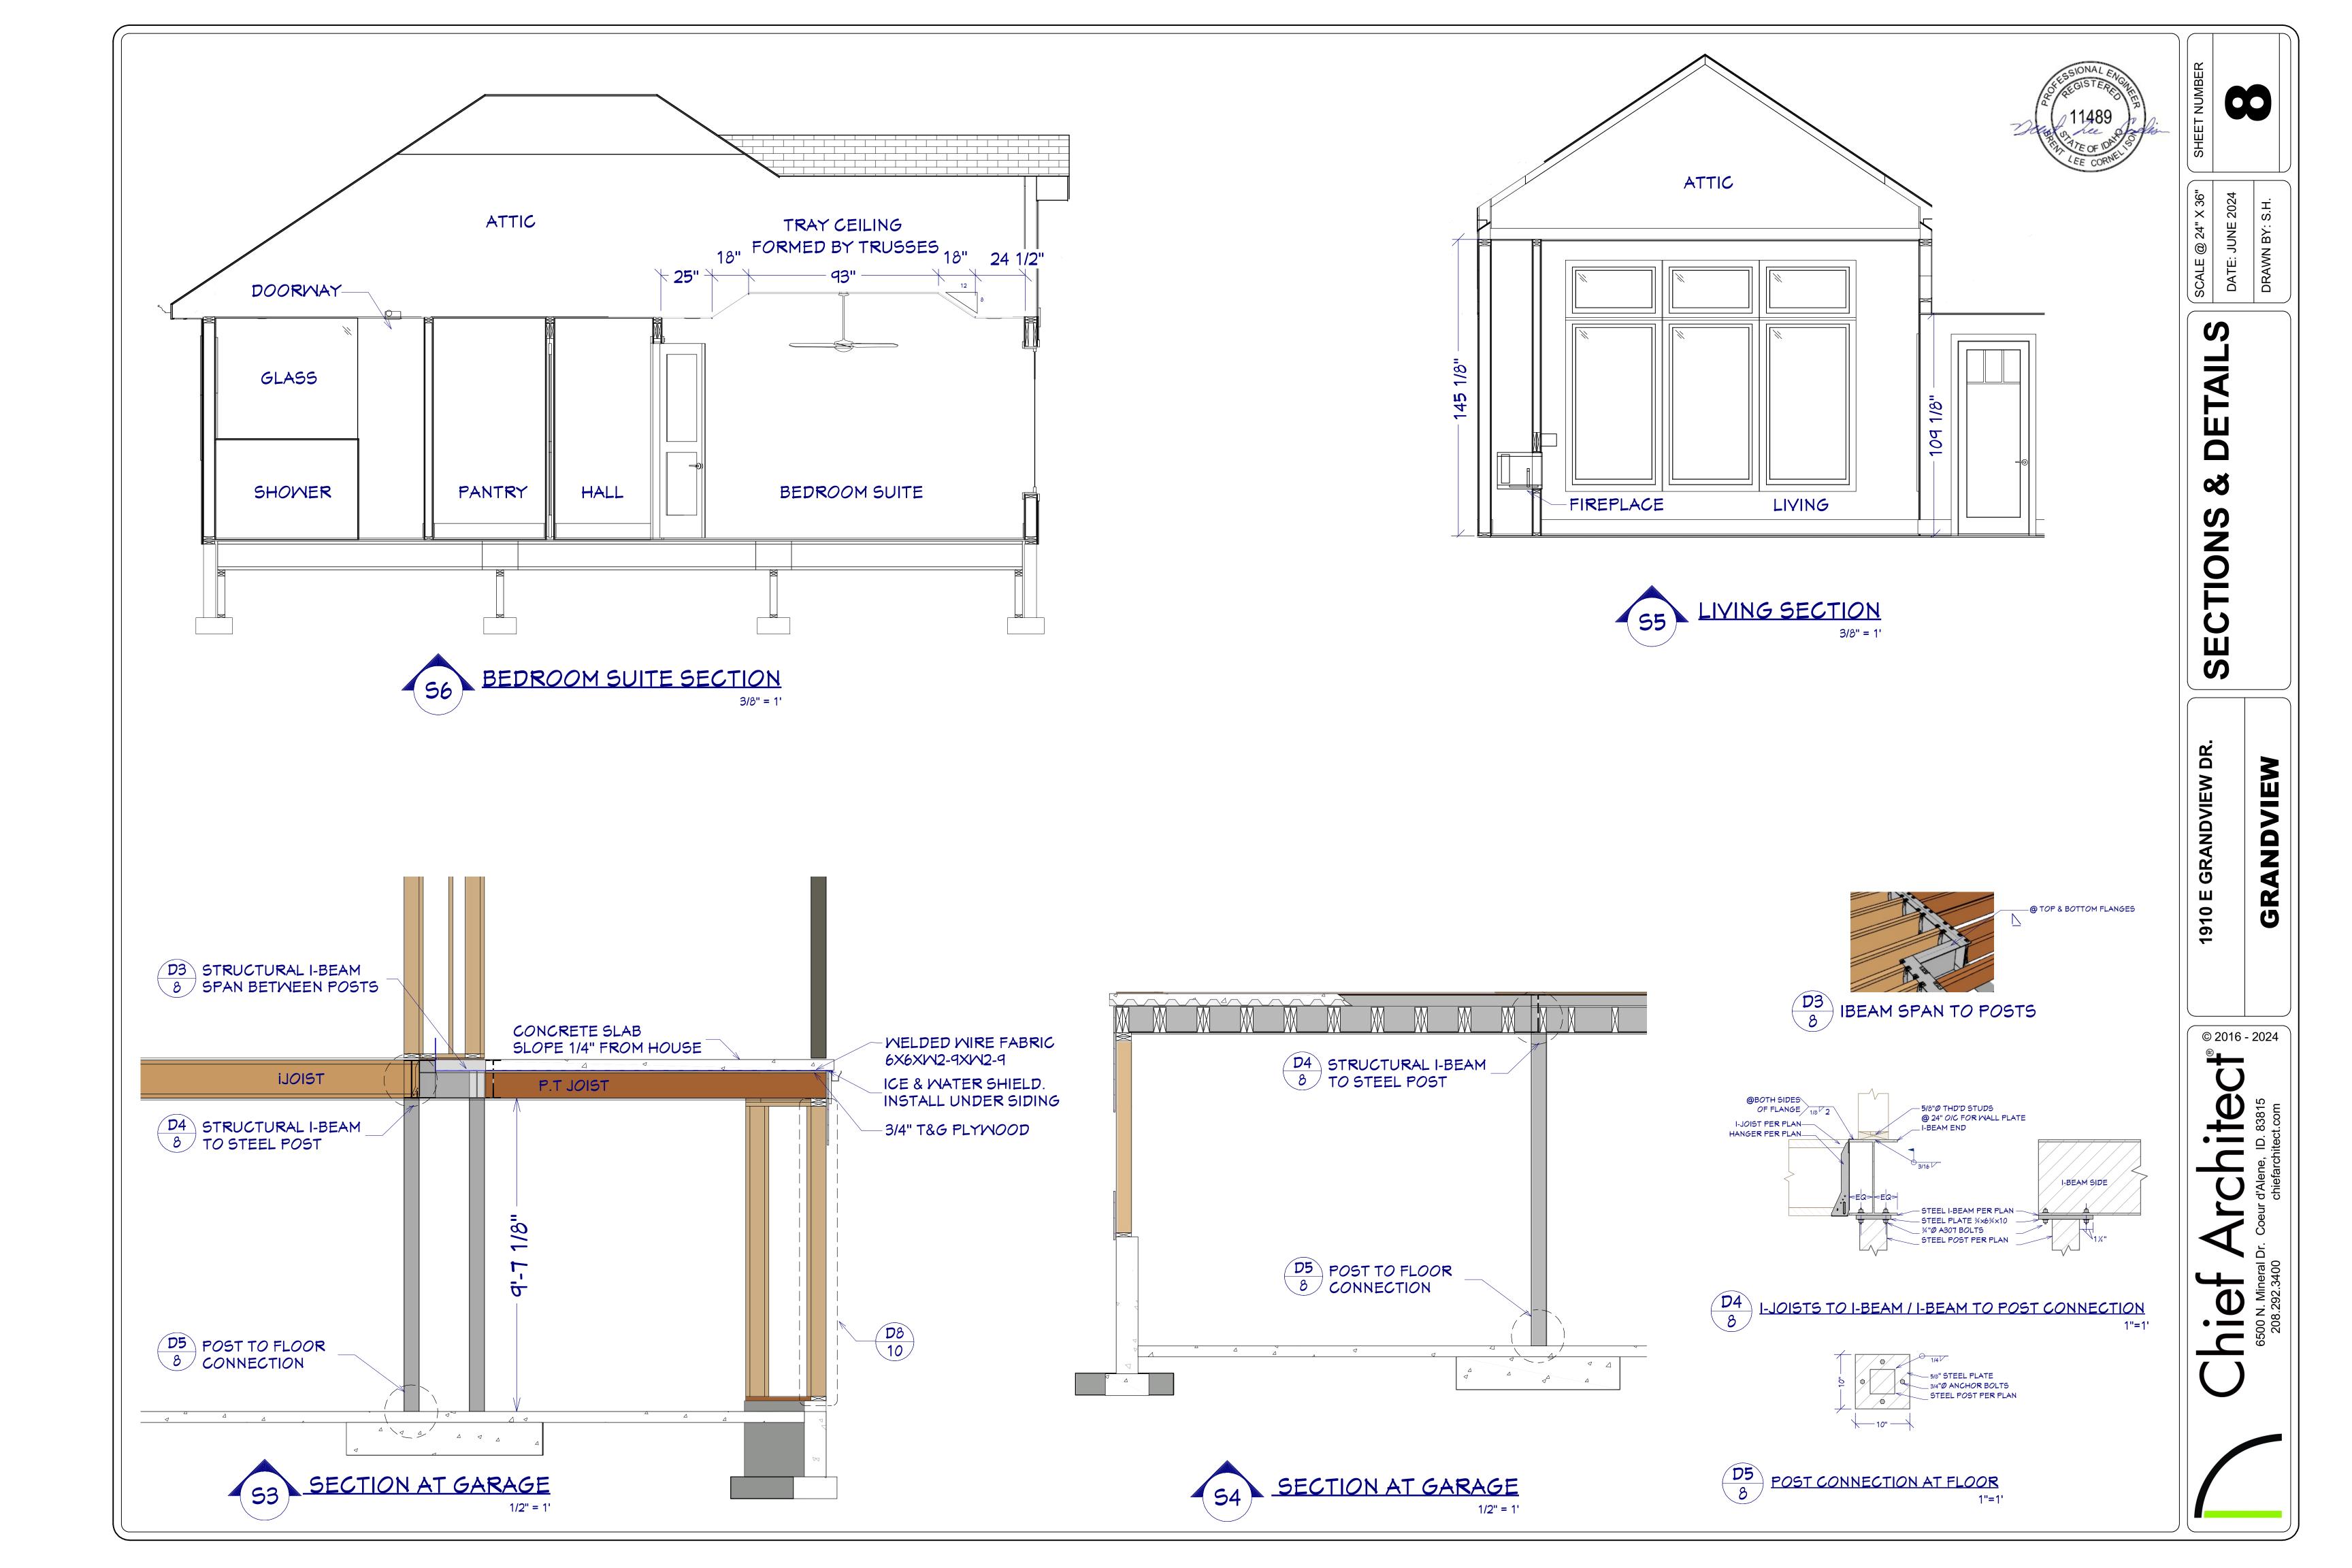
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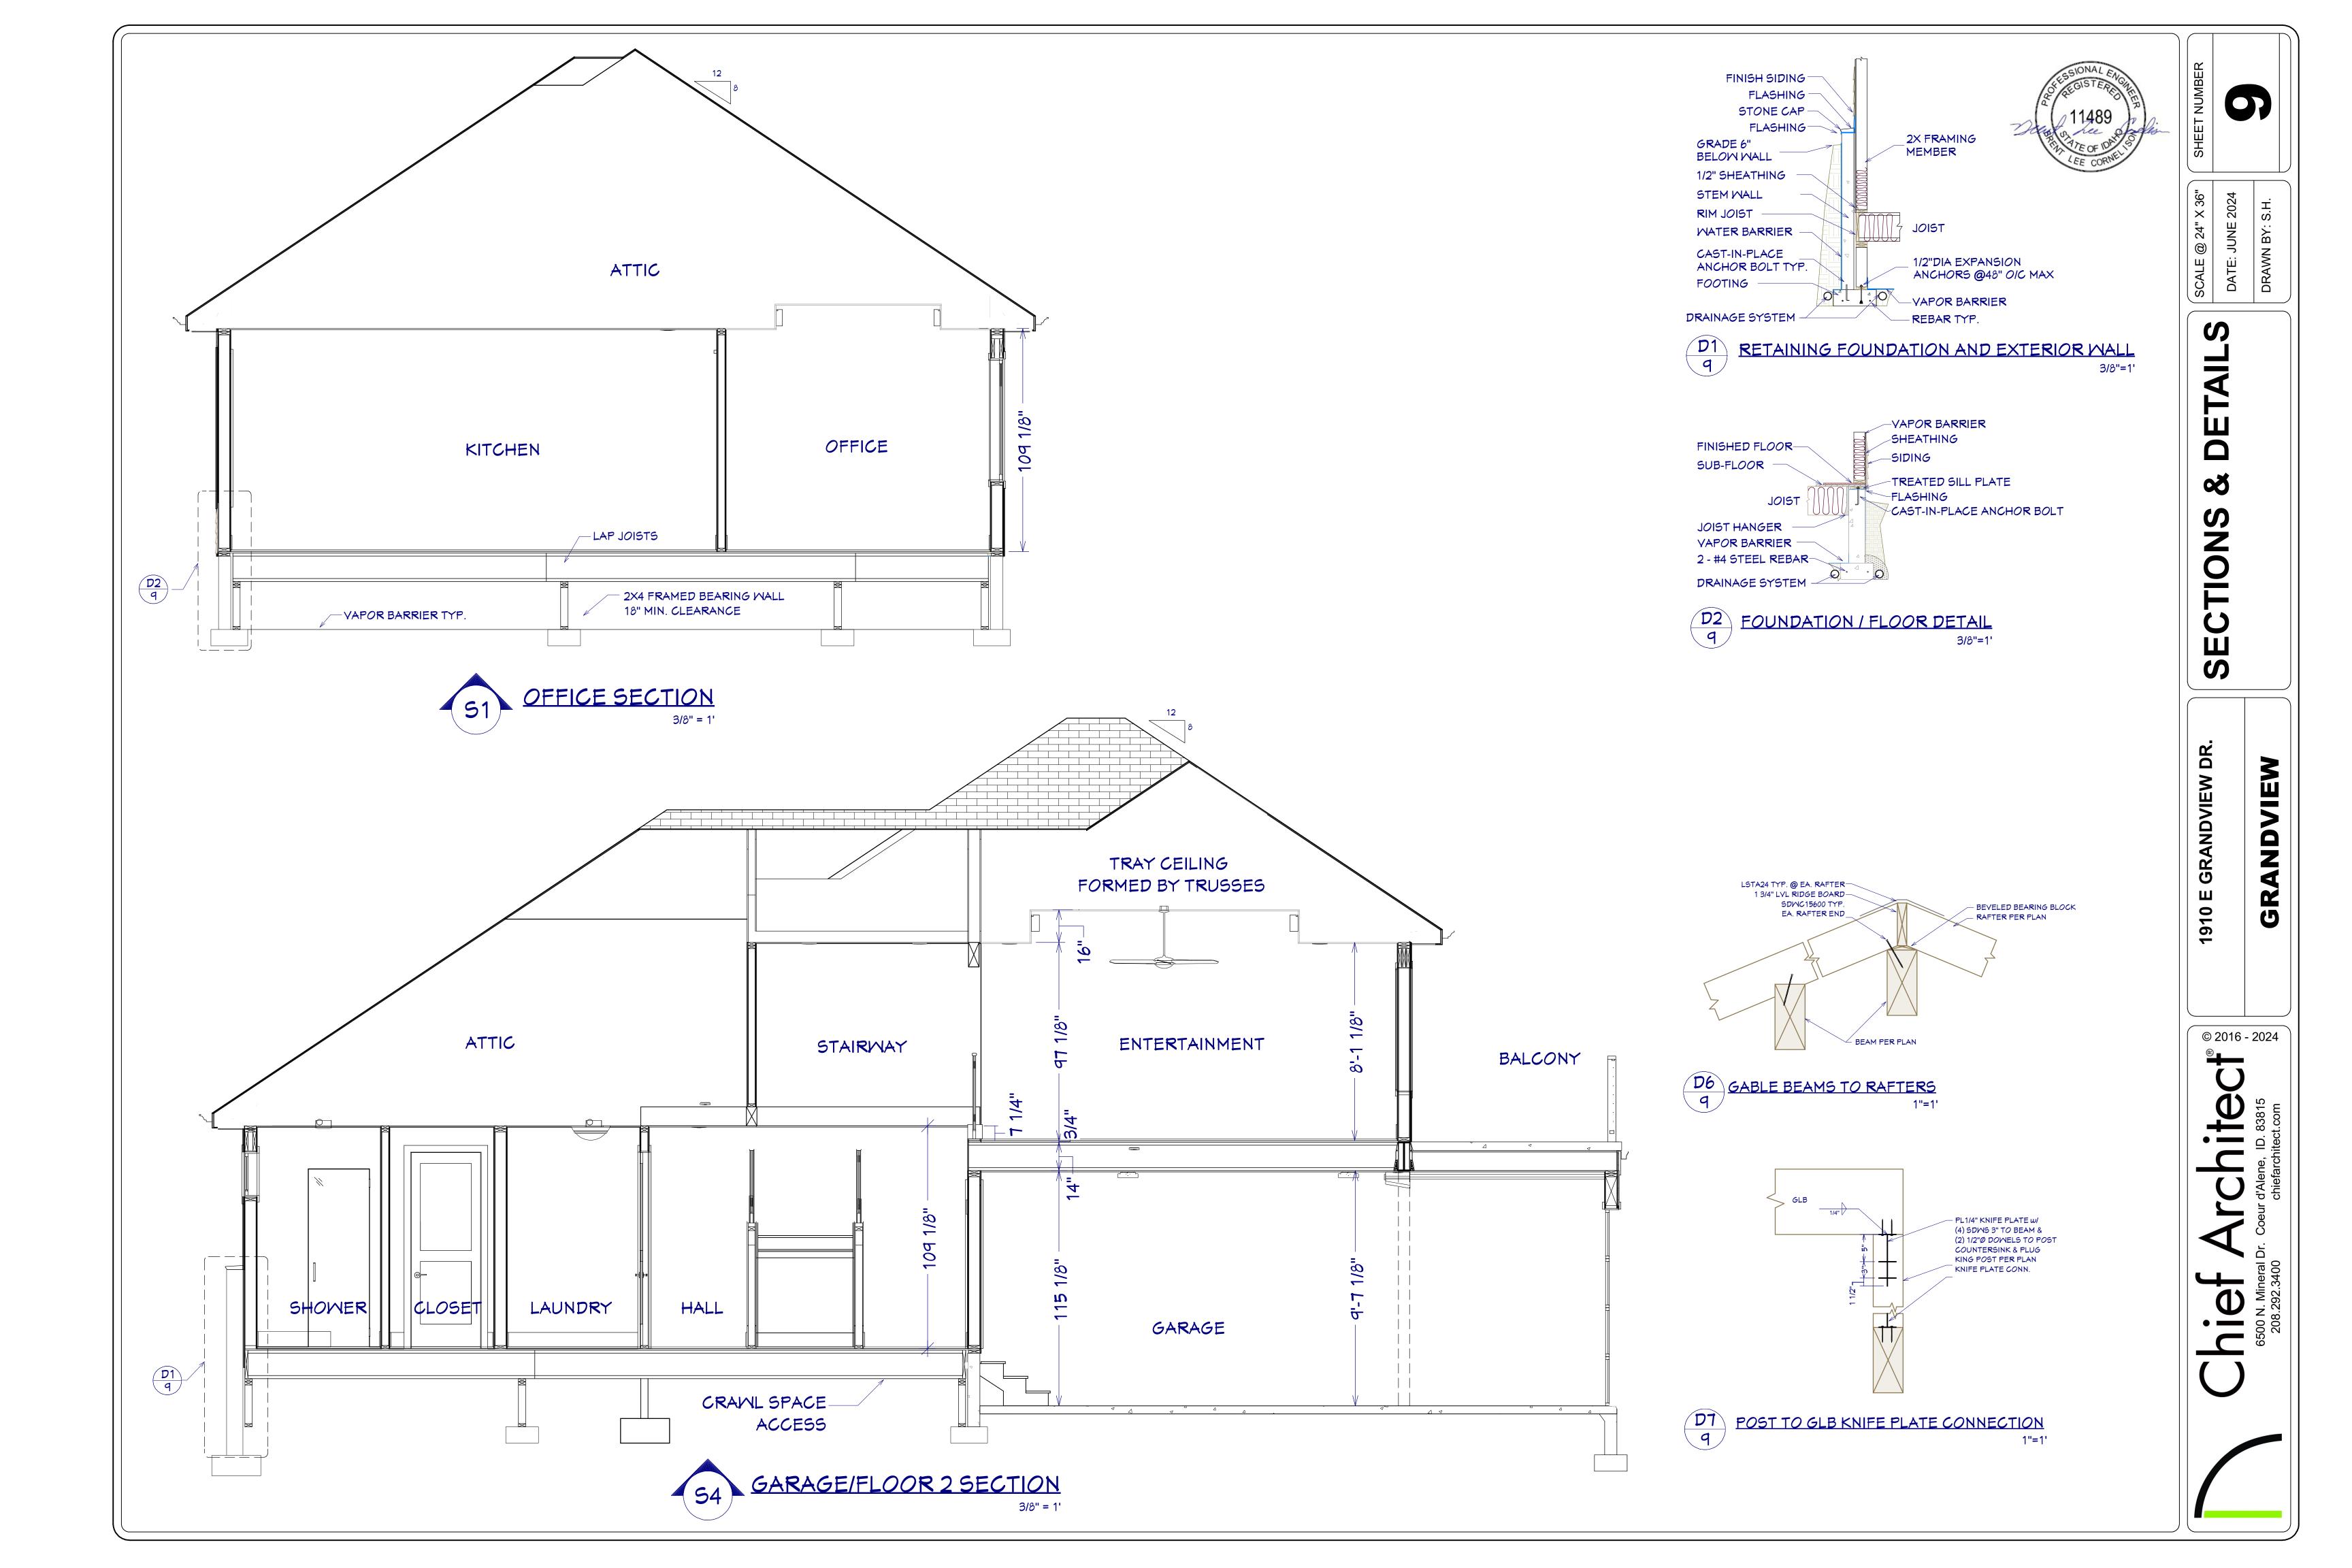
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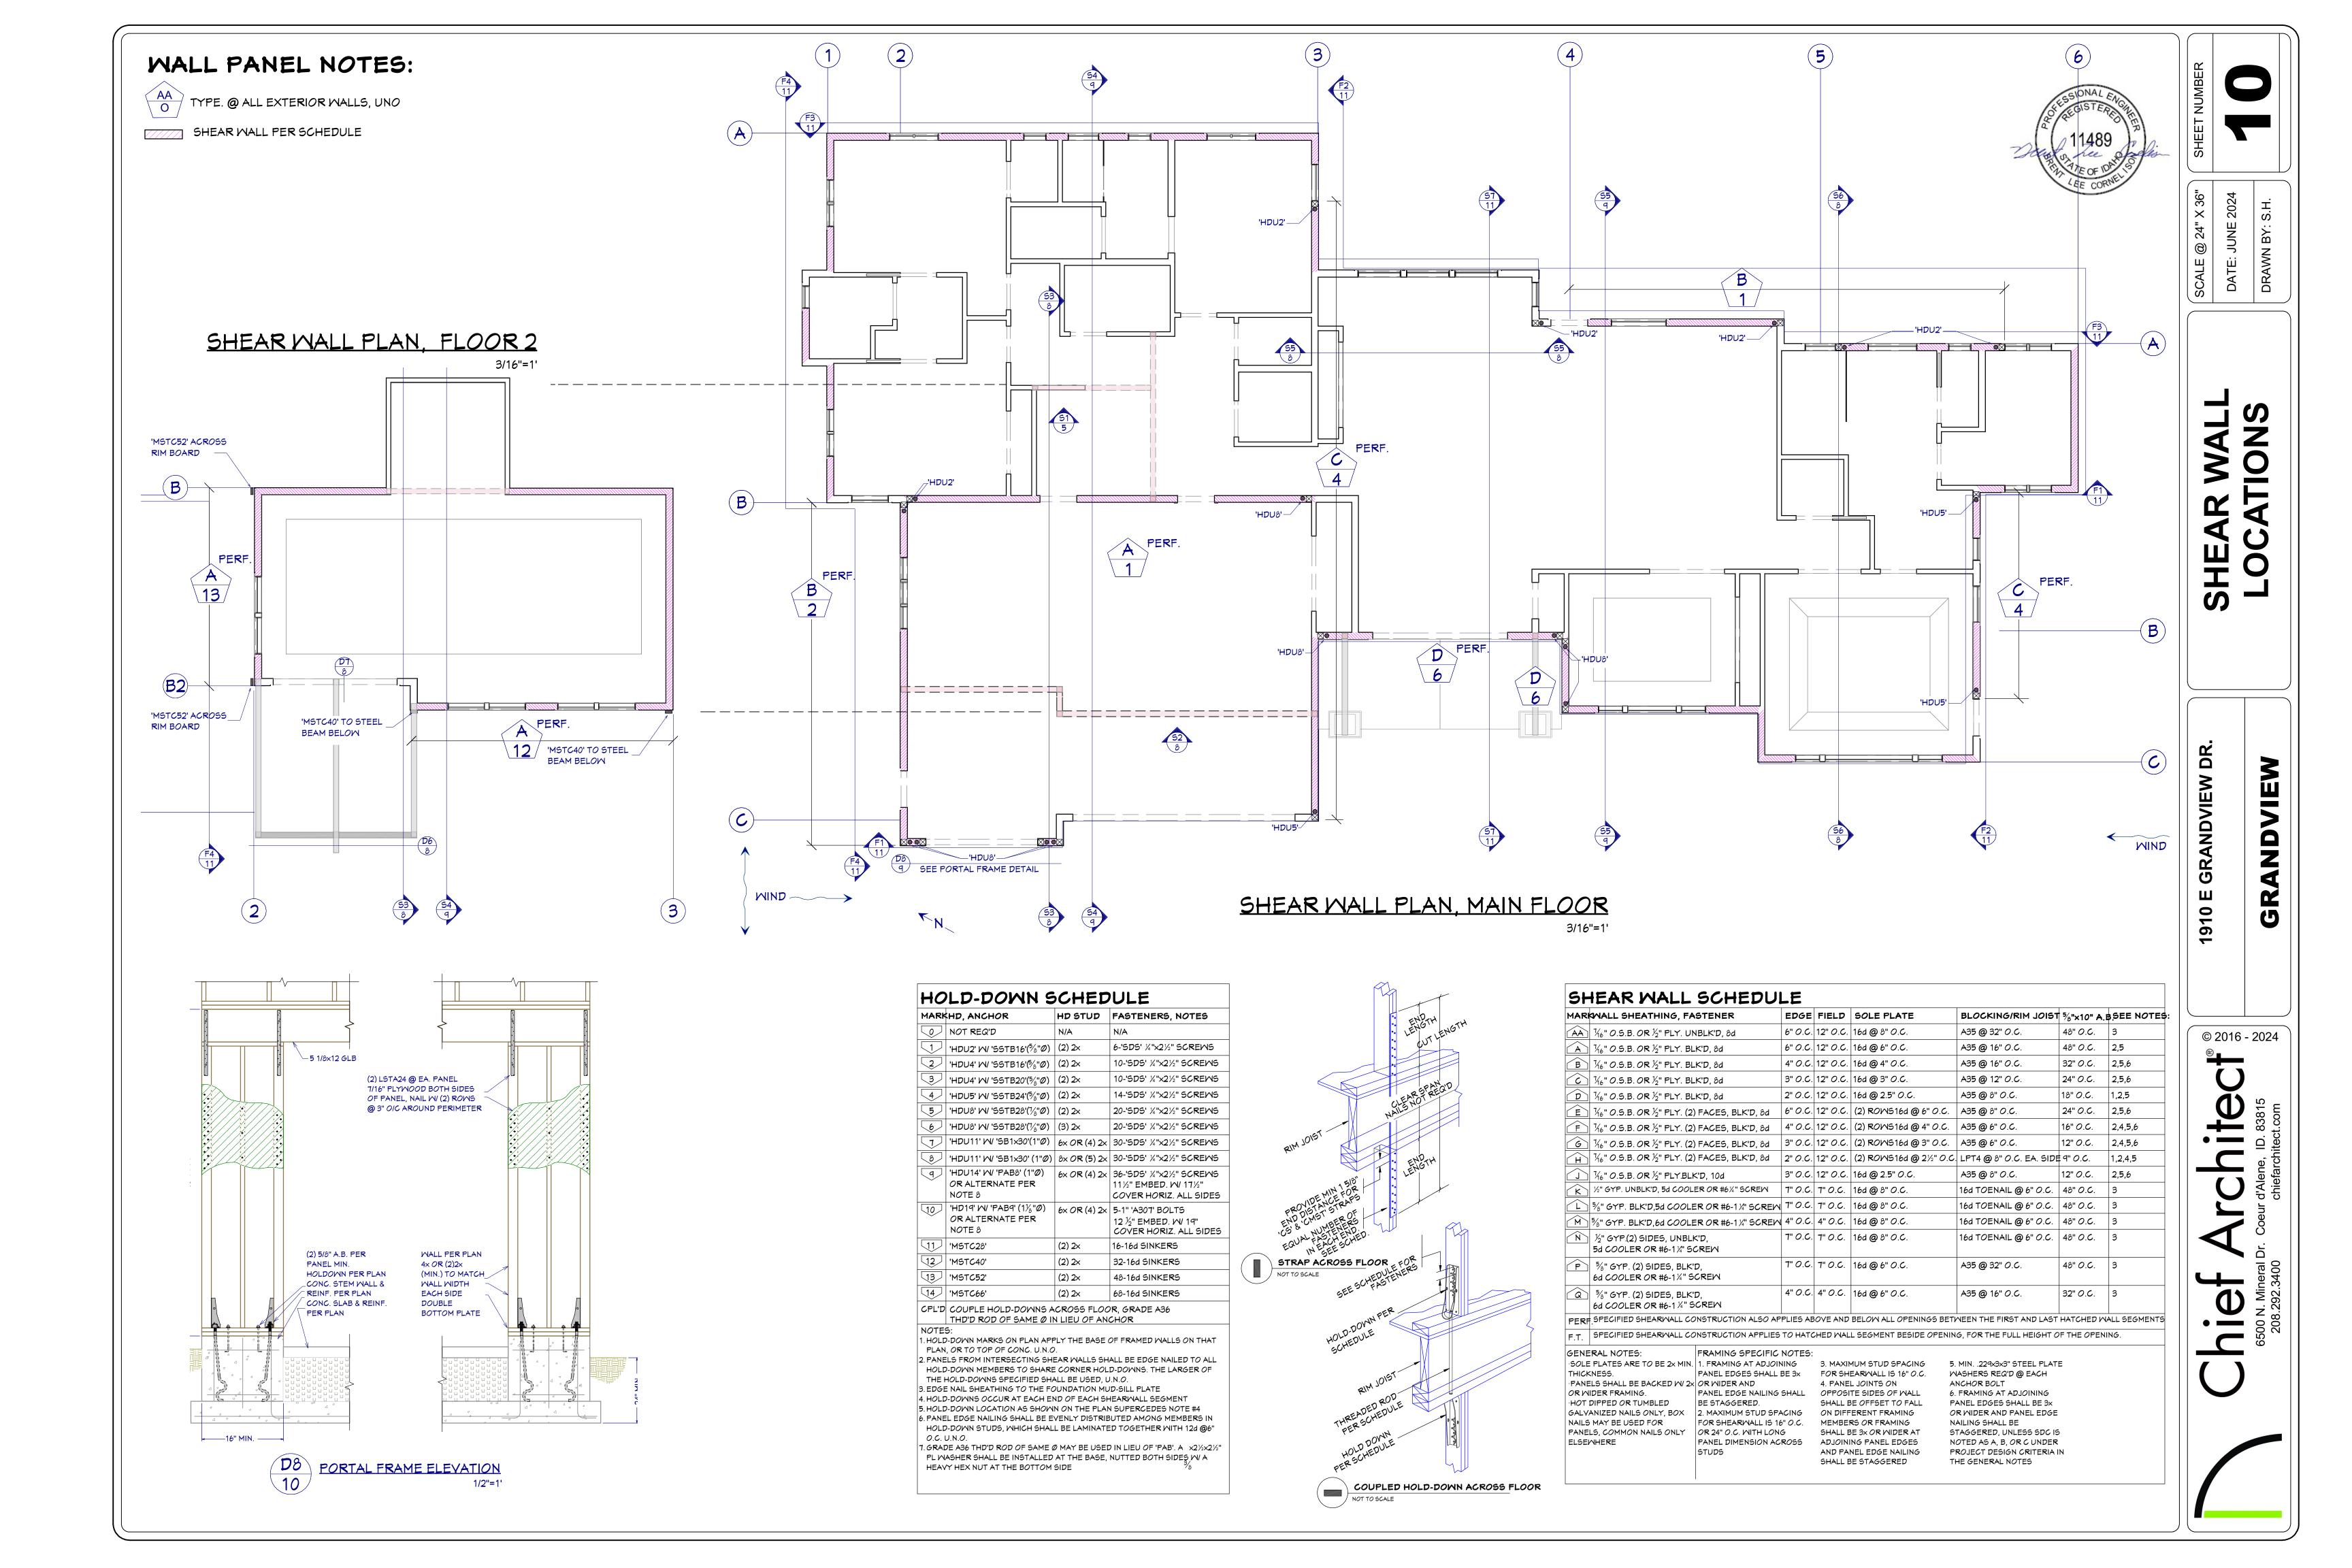
N. Mineral Dr. Coeur d'Alene,













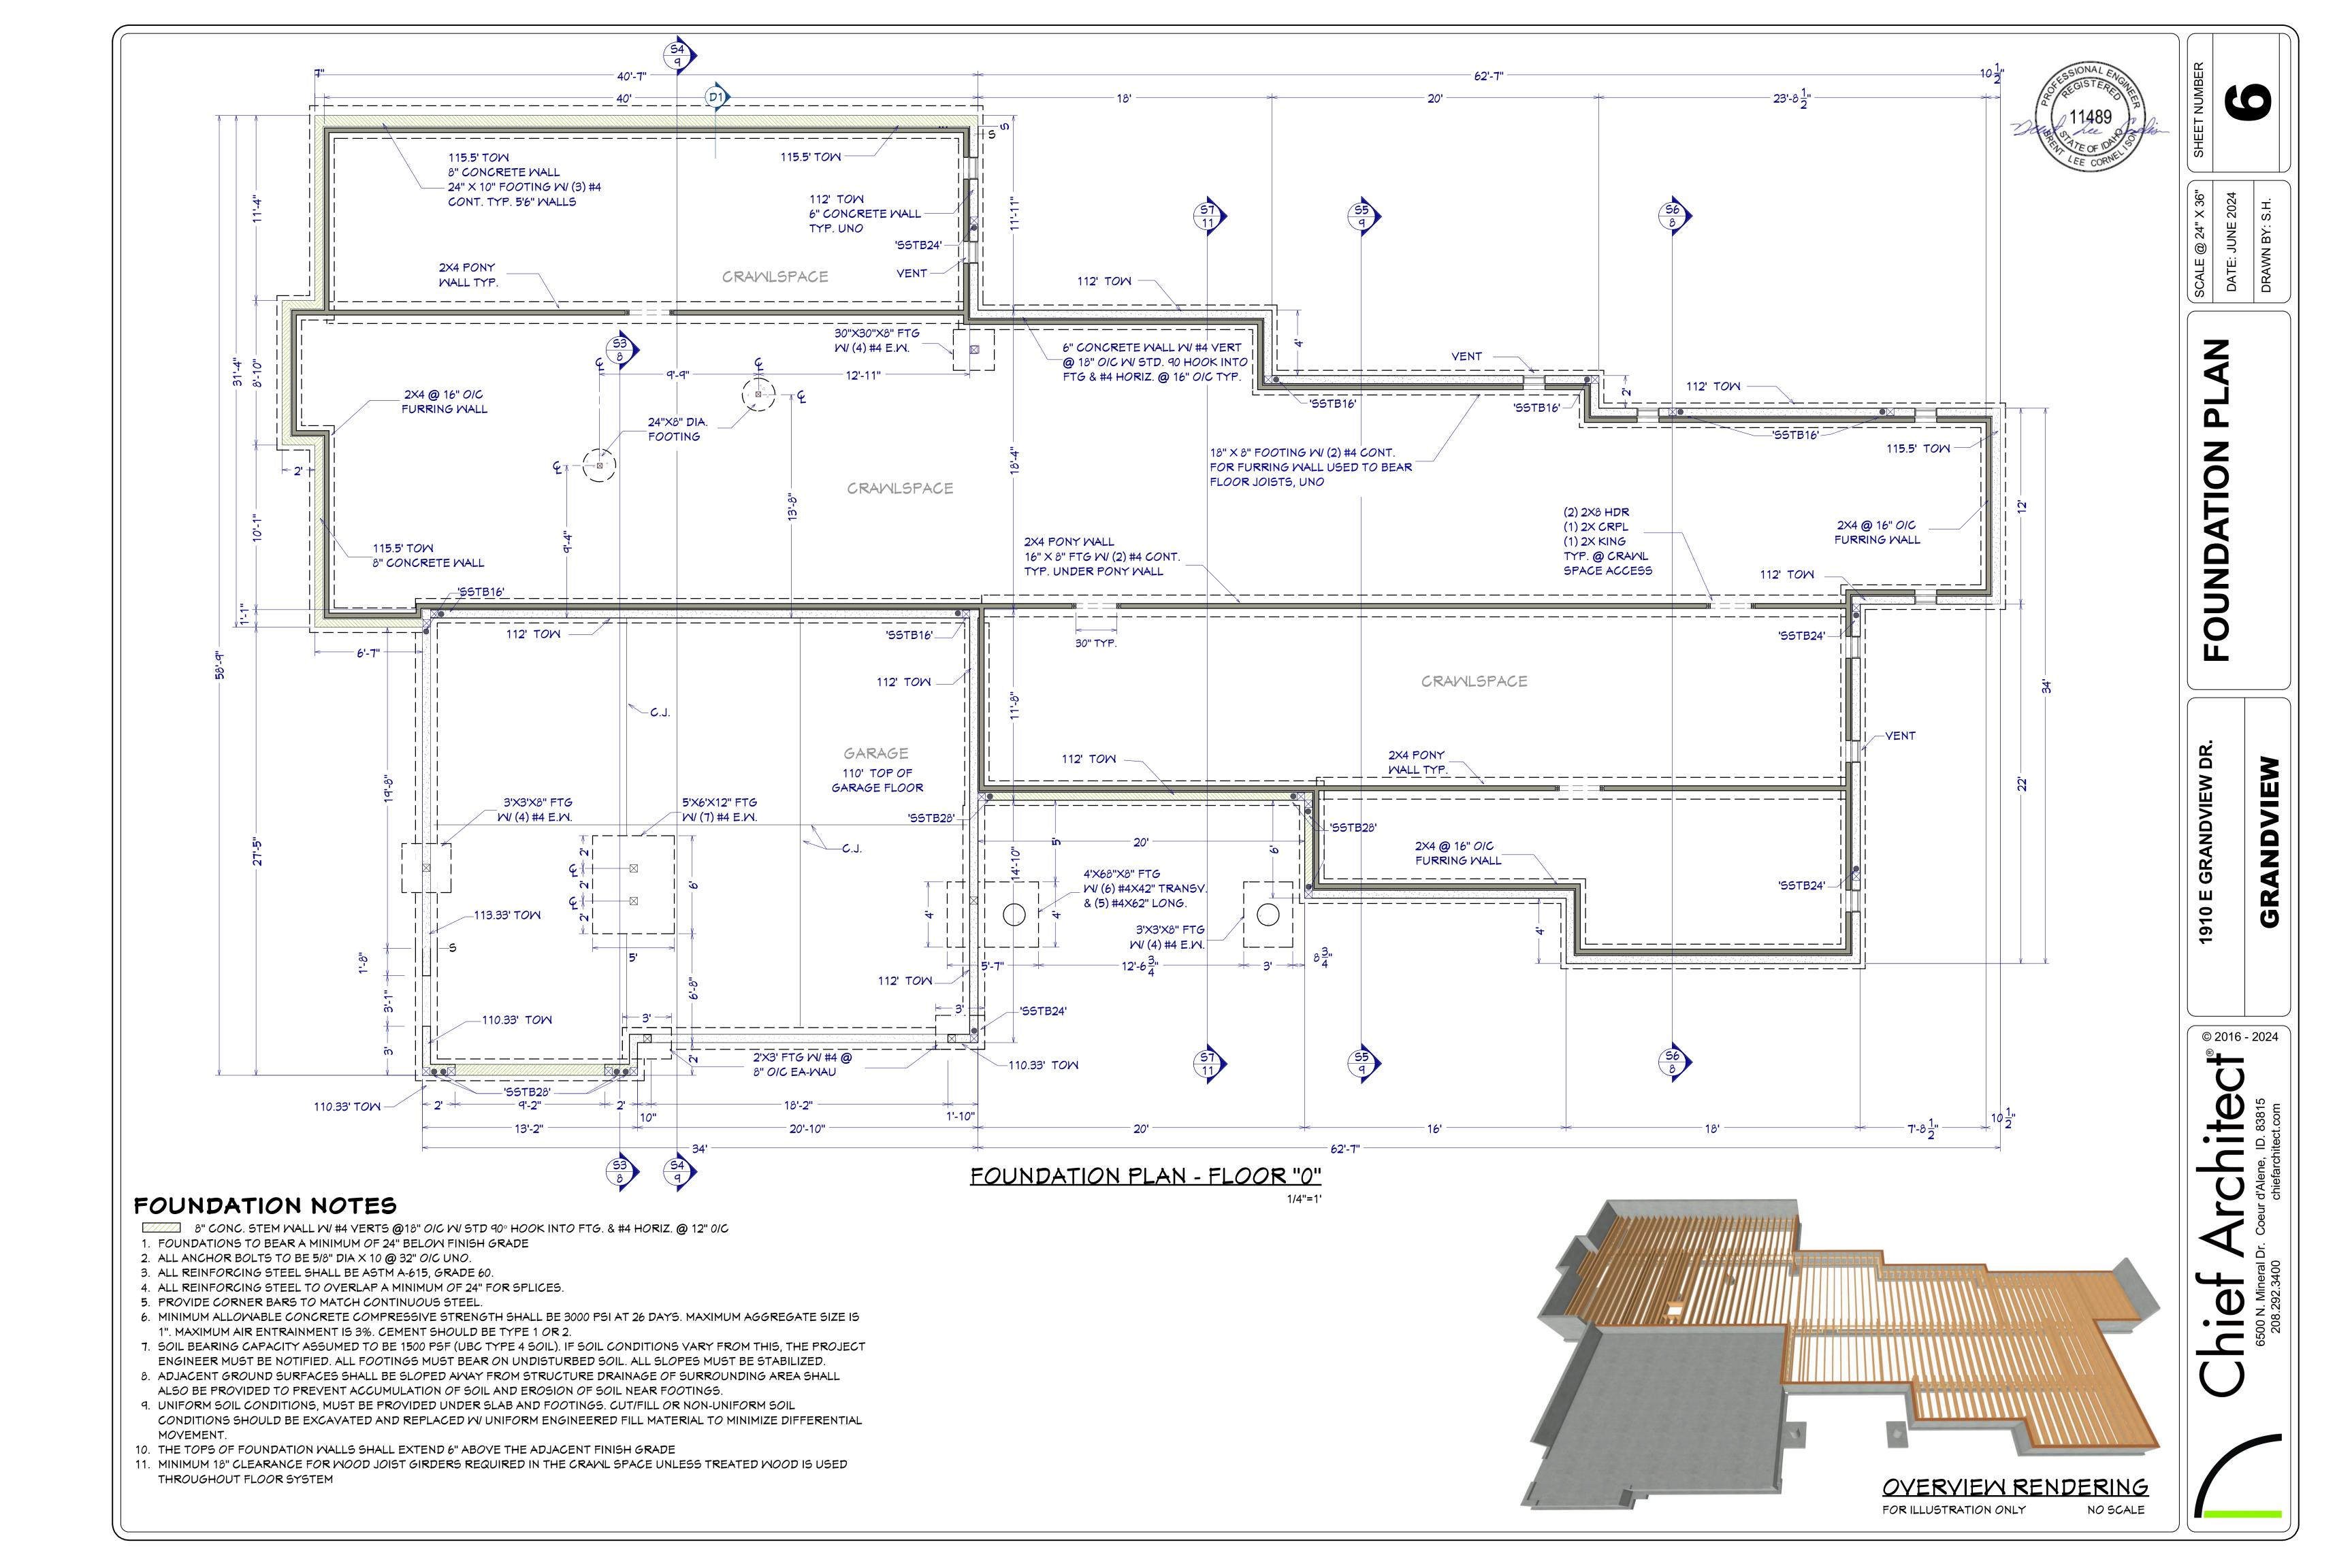


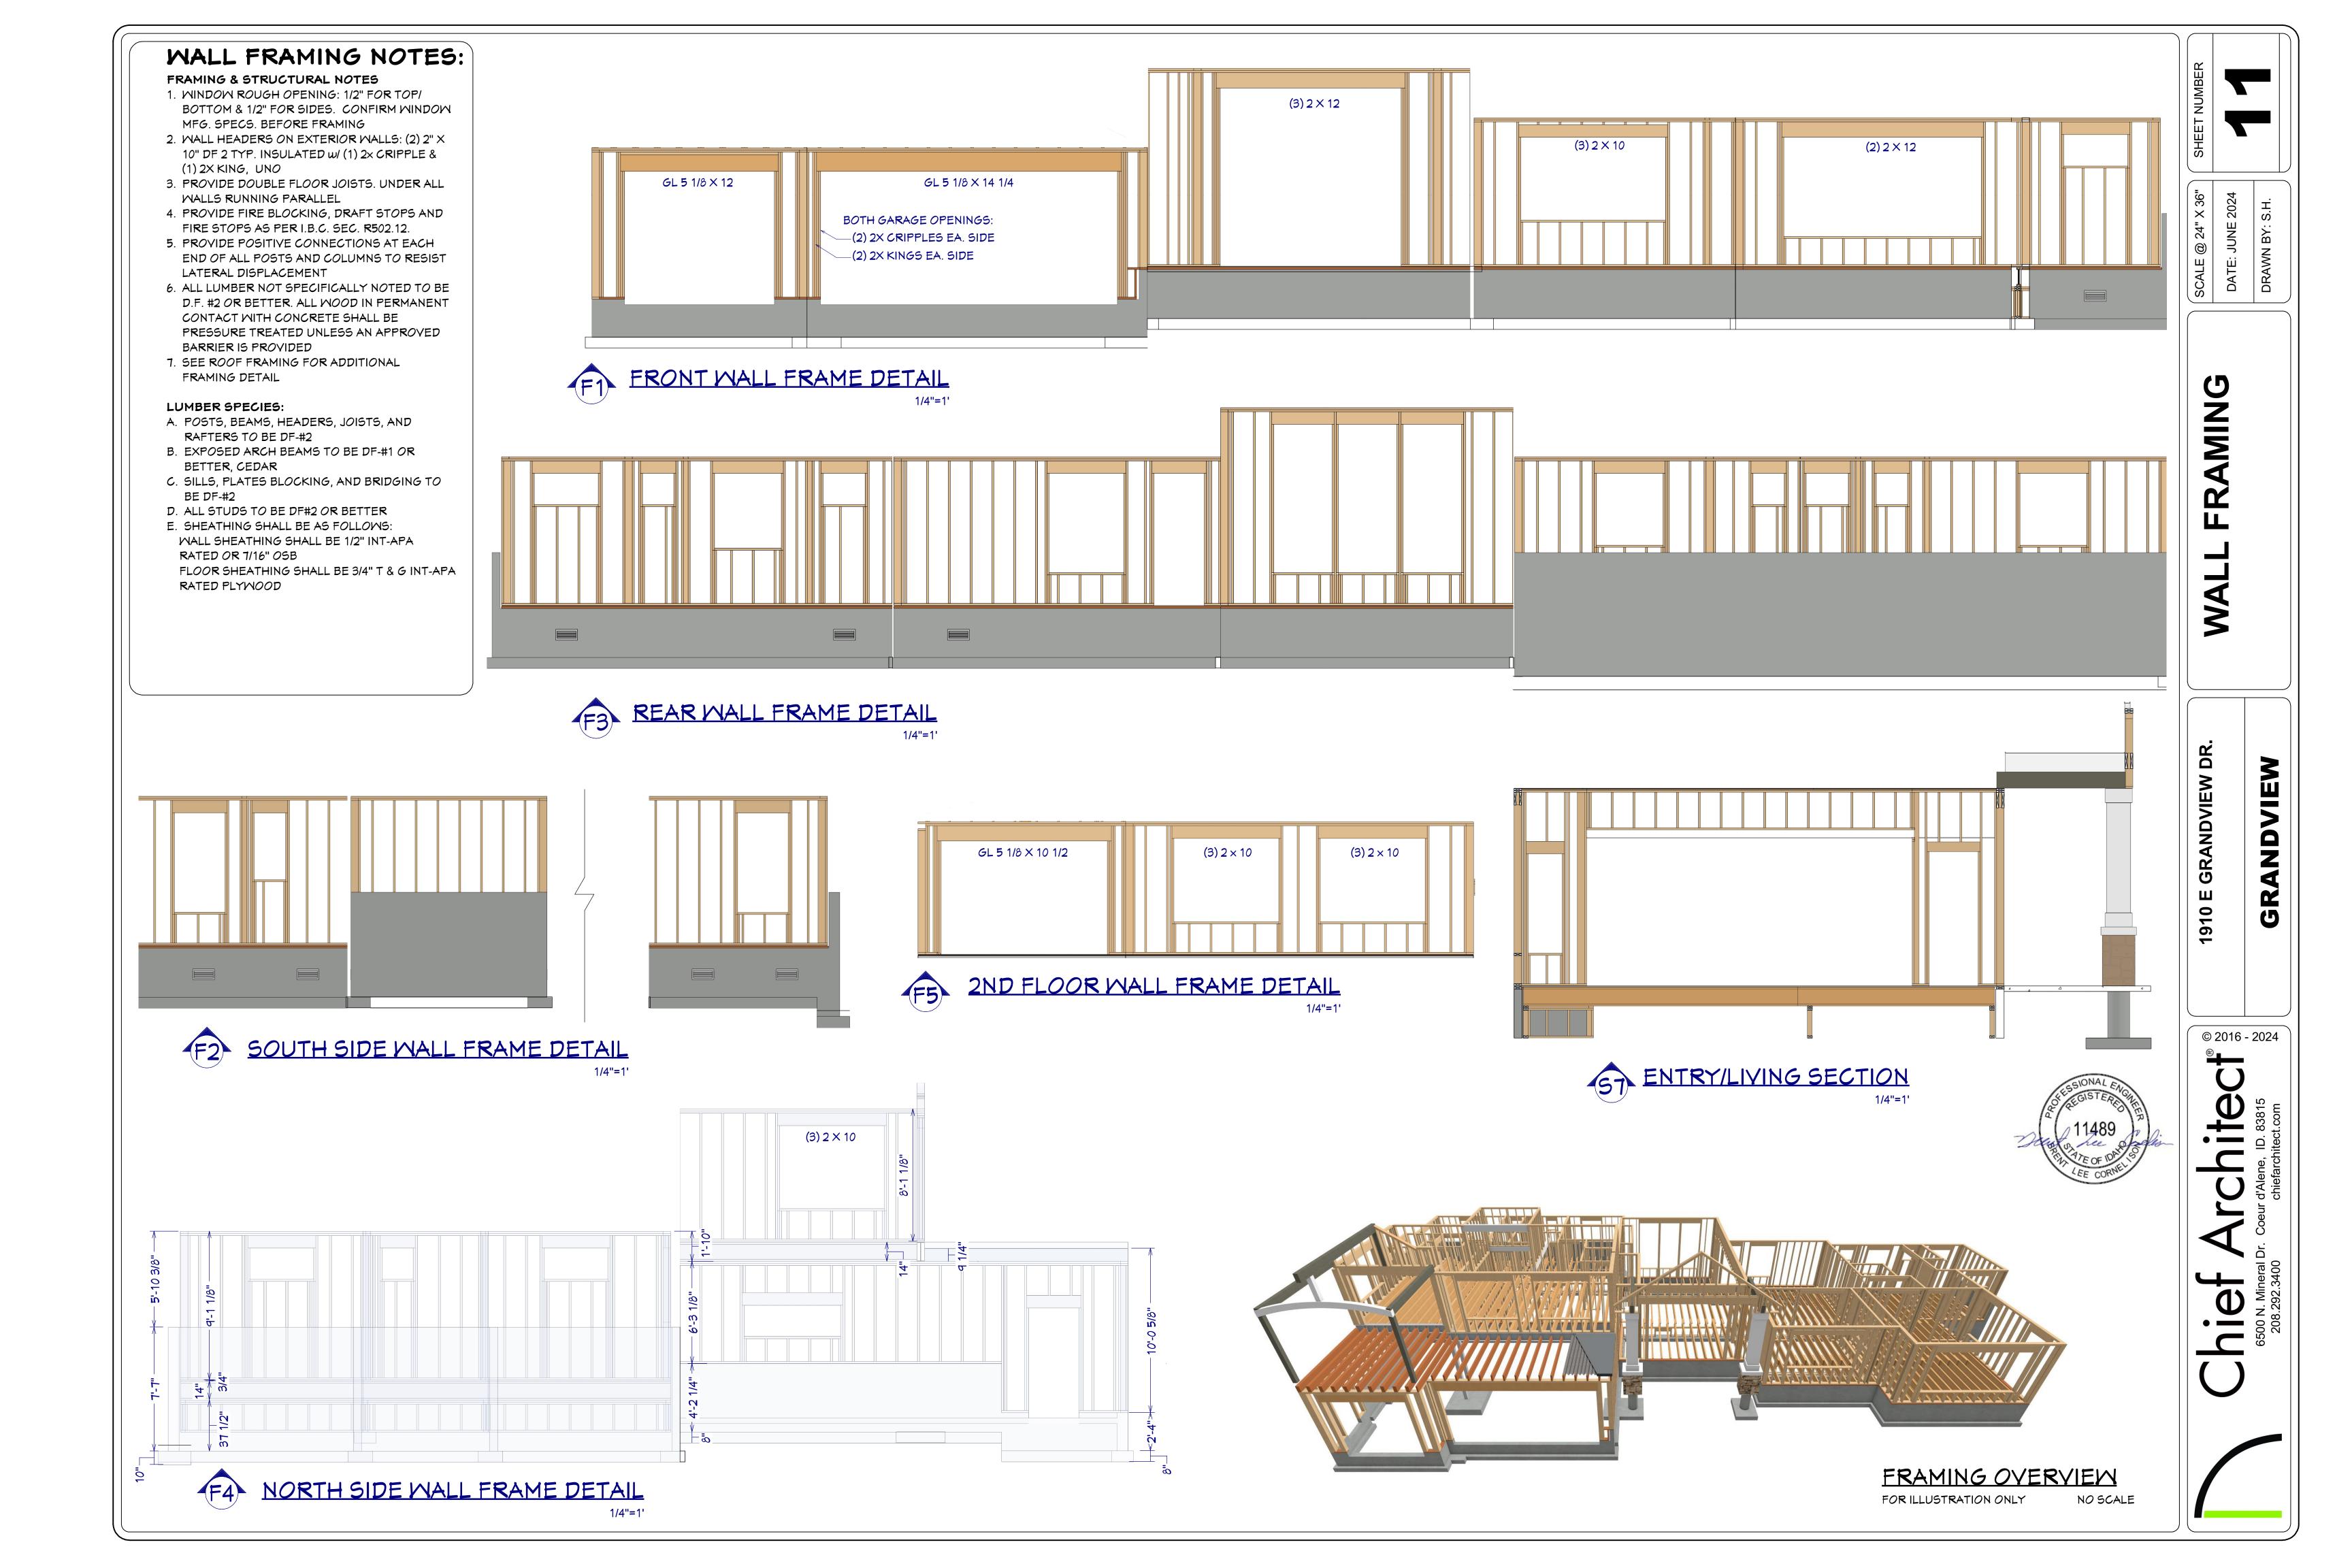

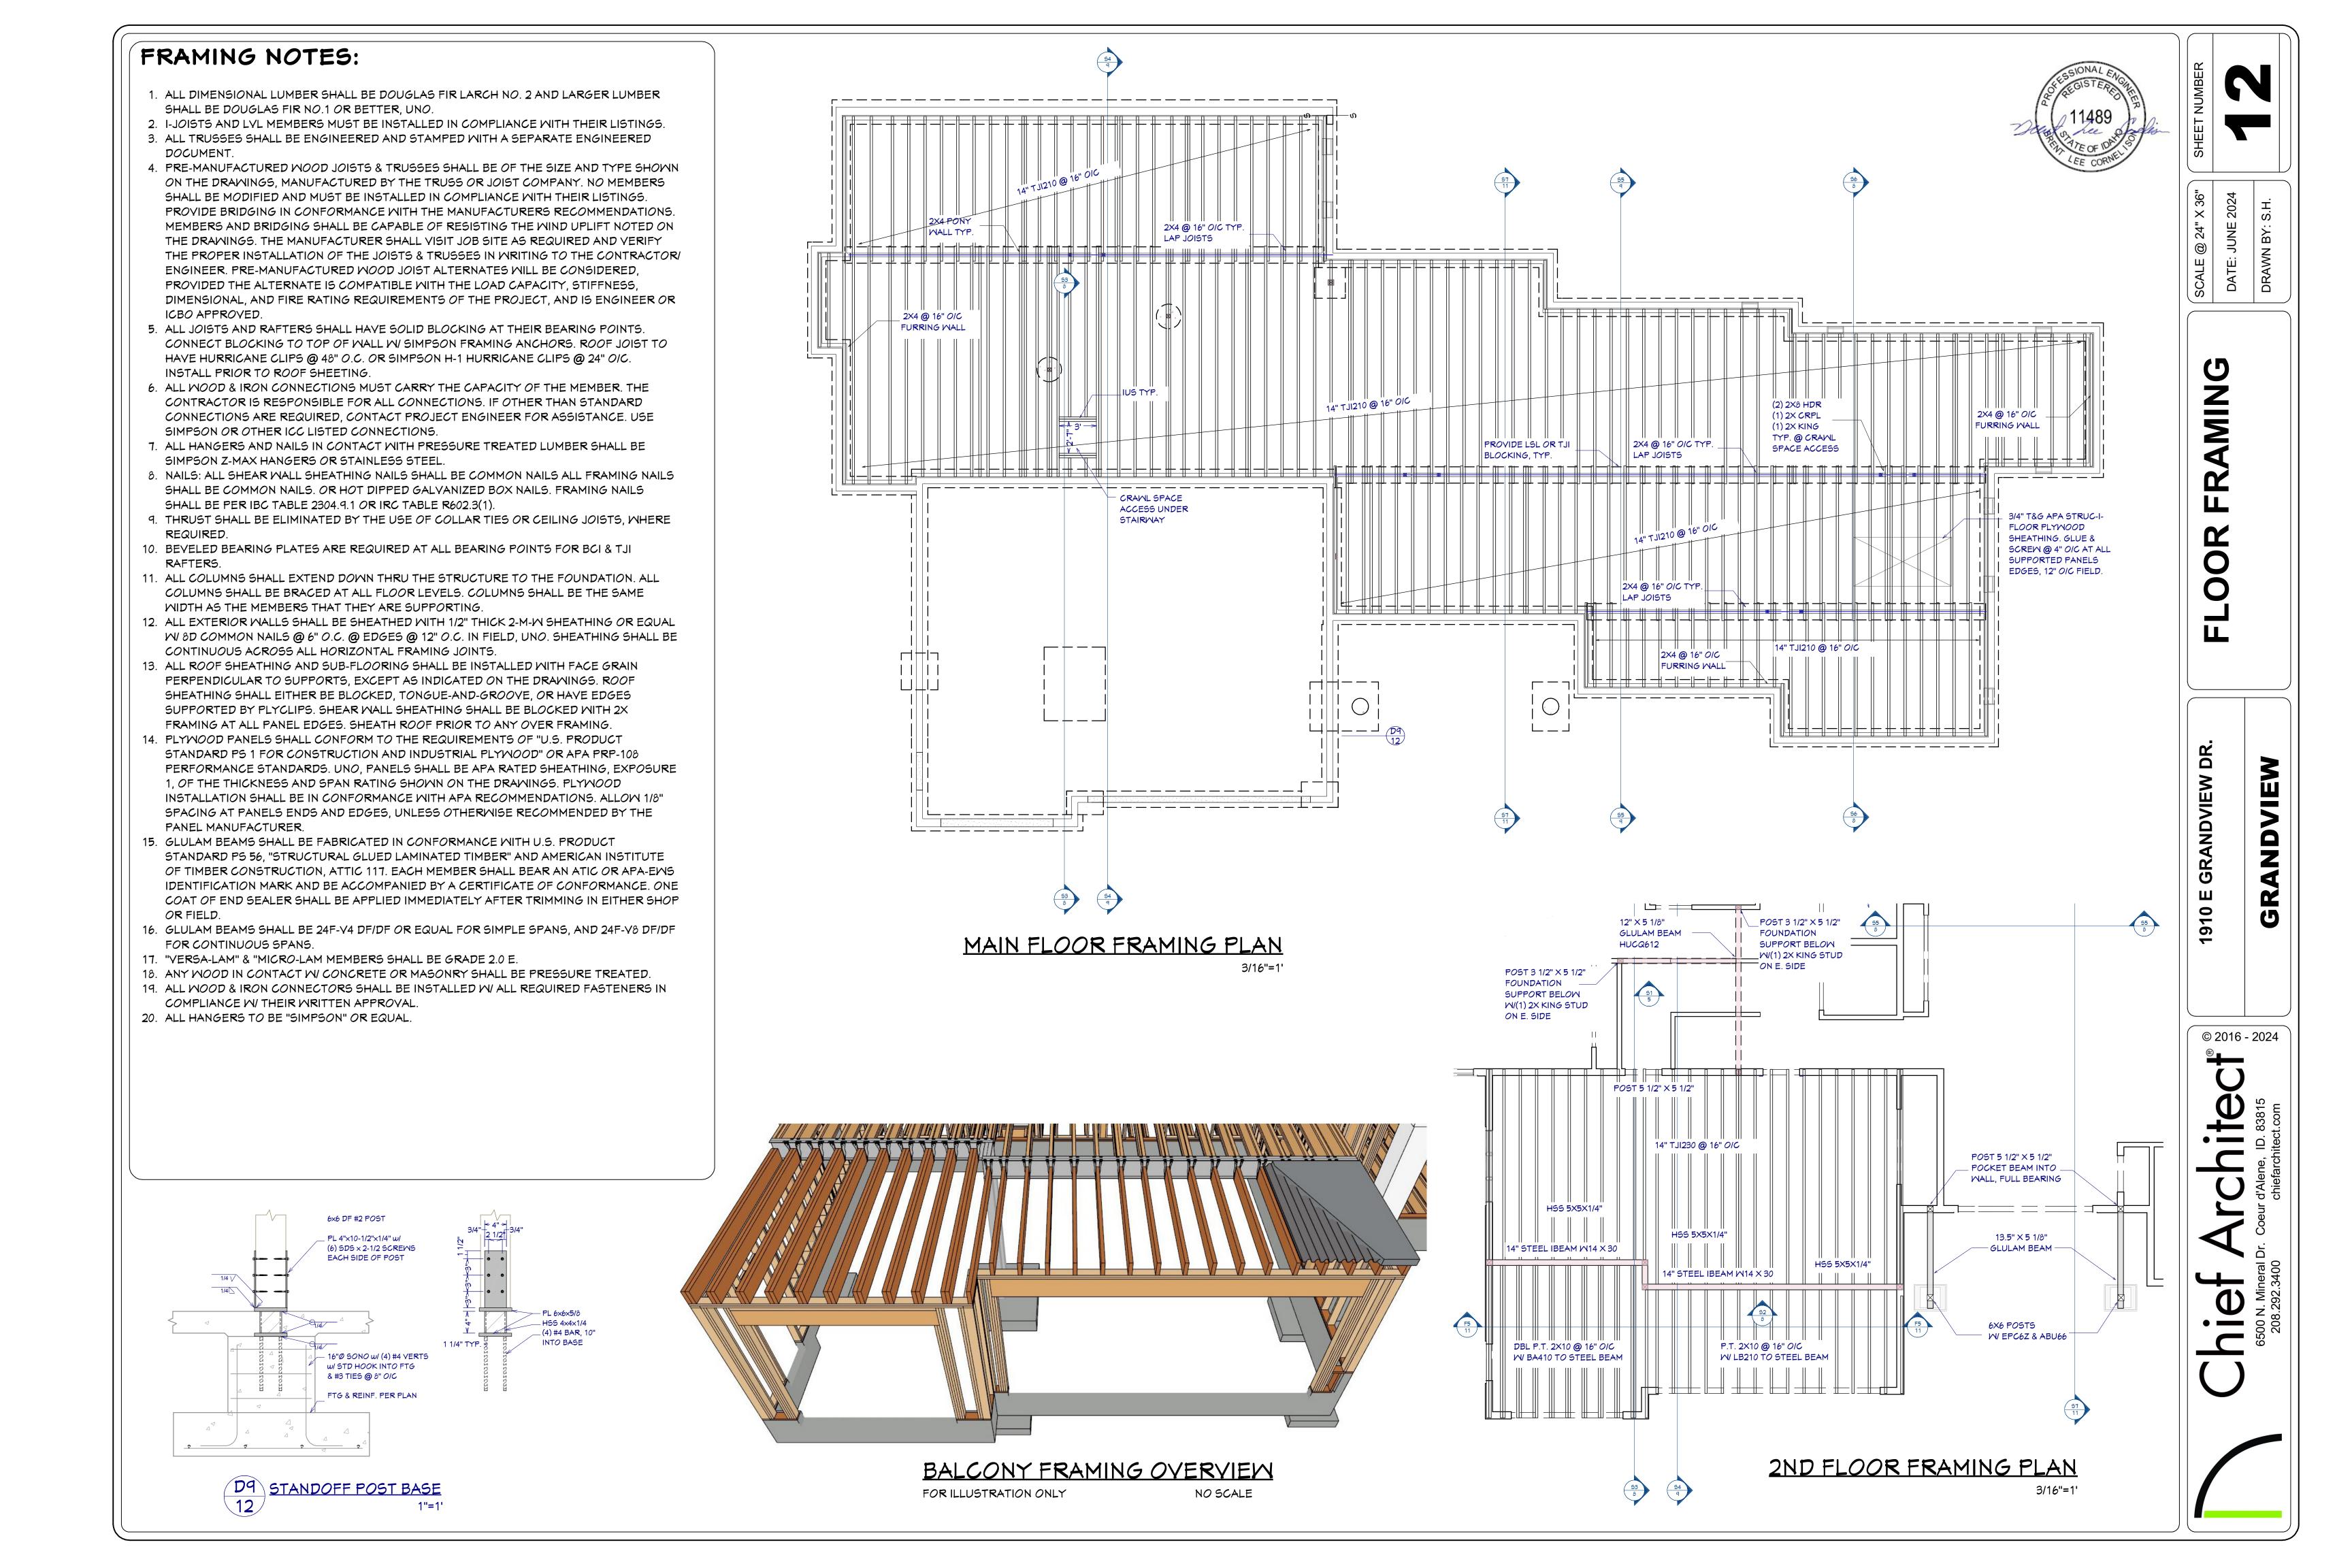

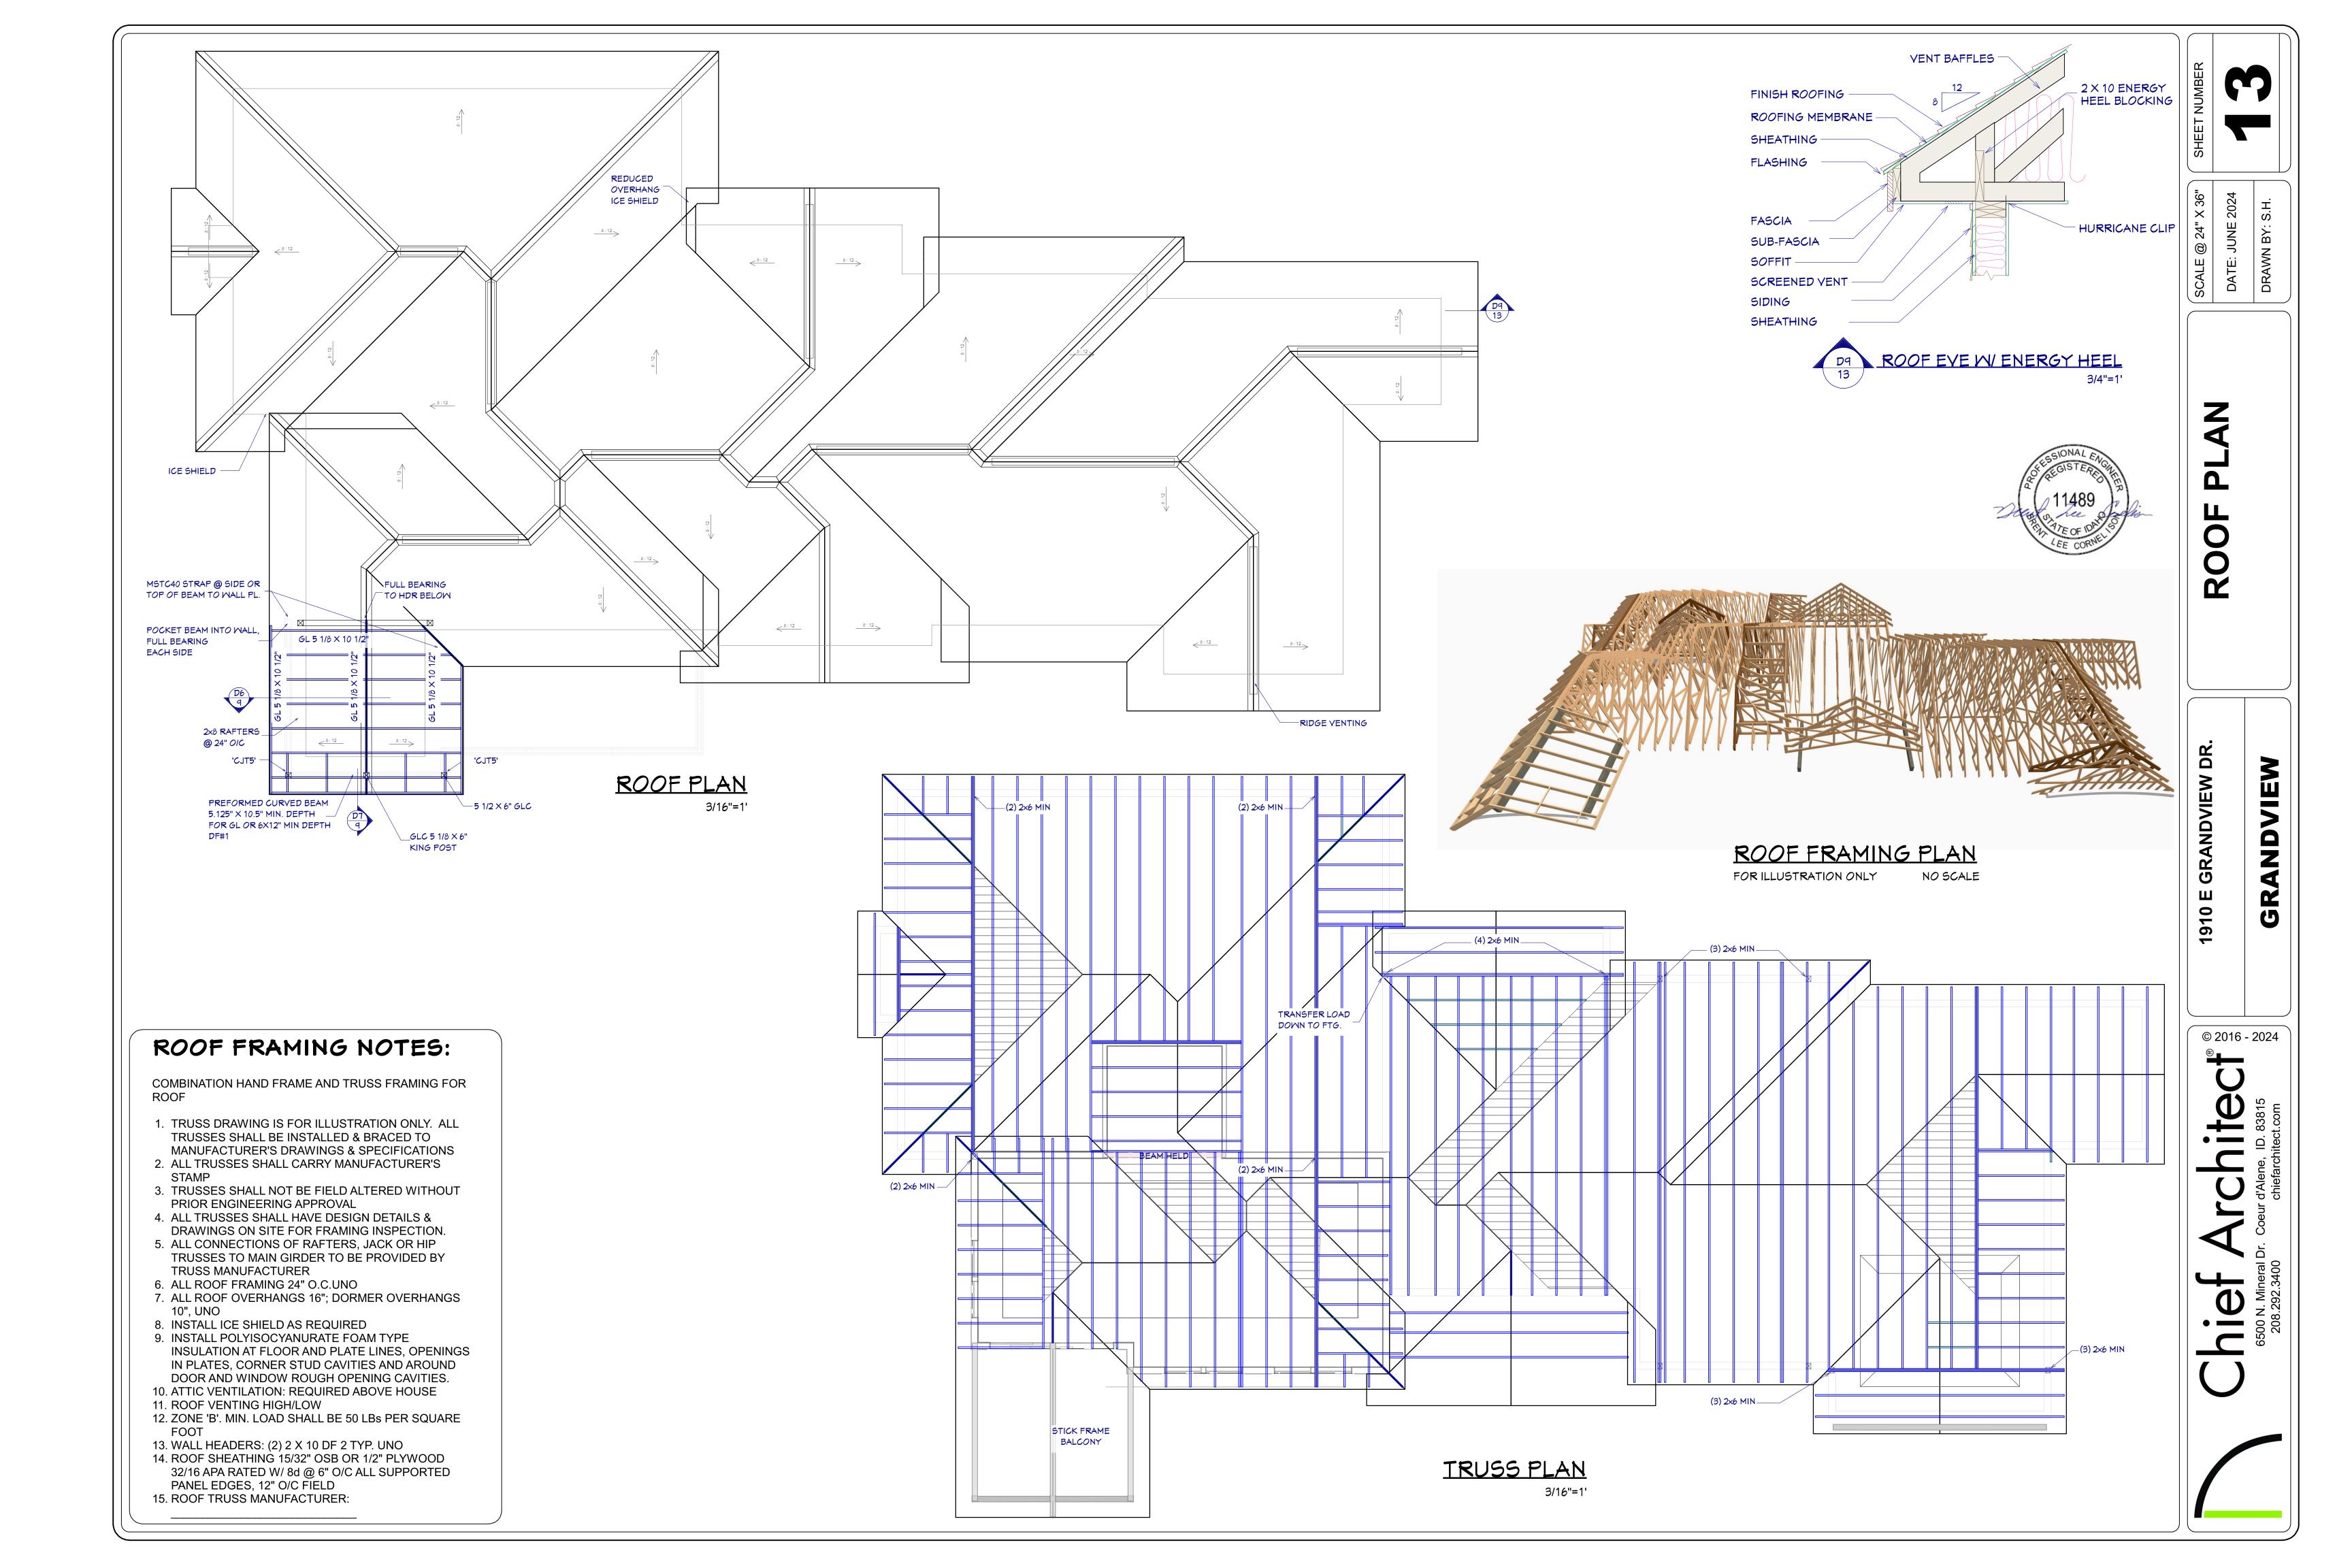

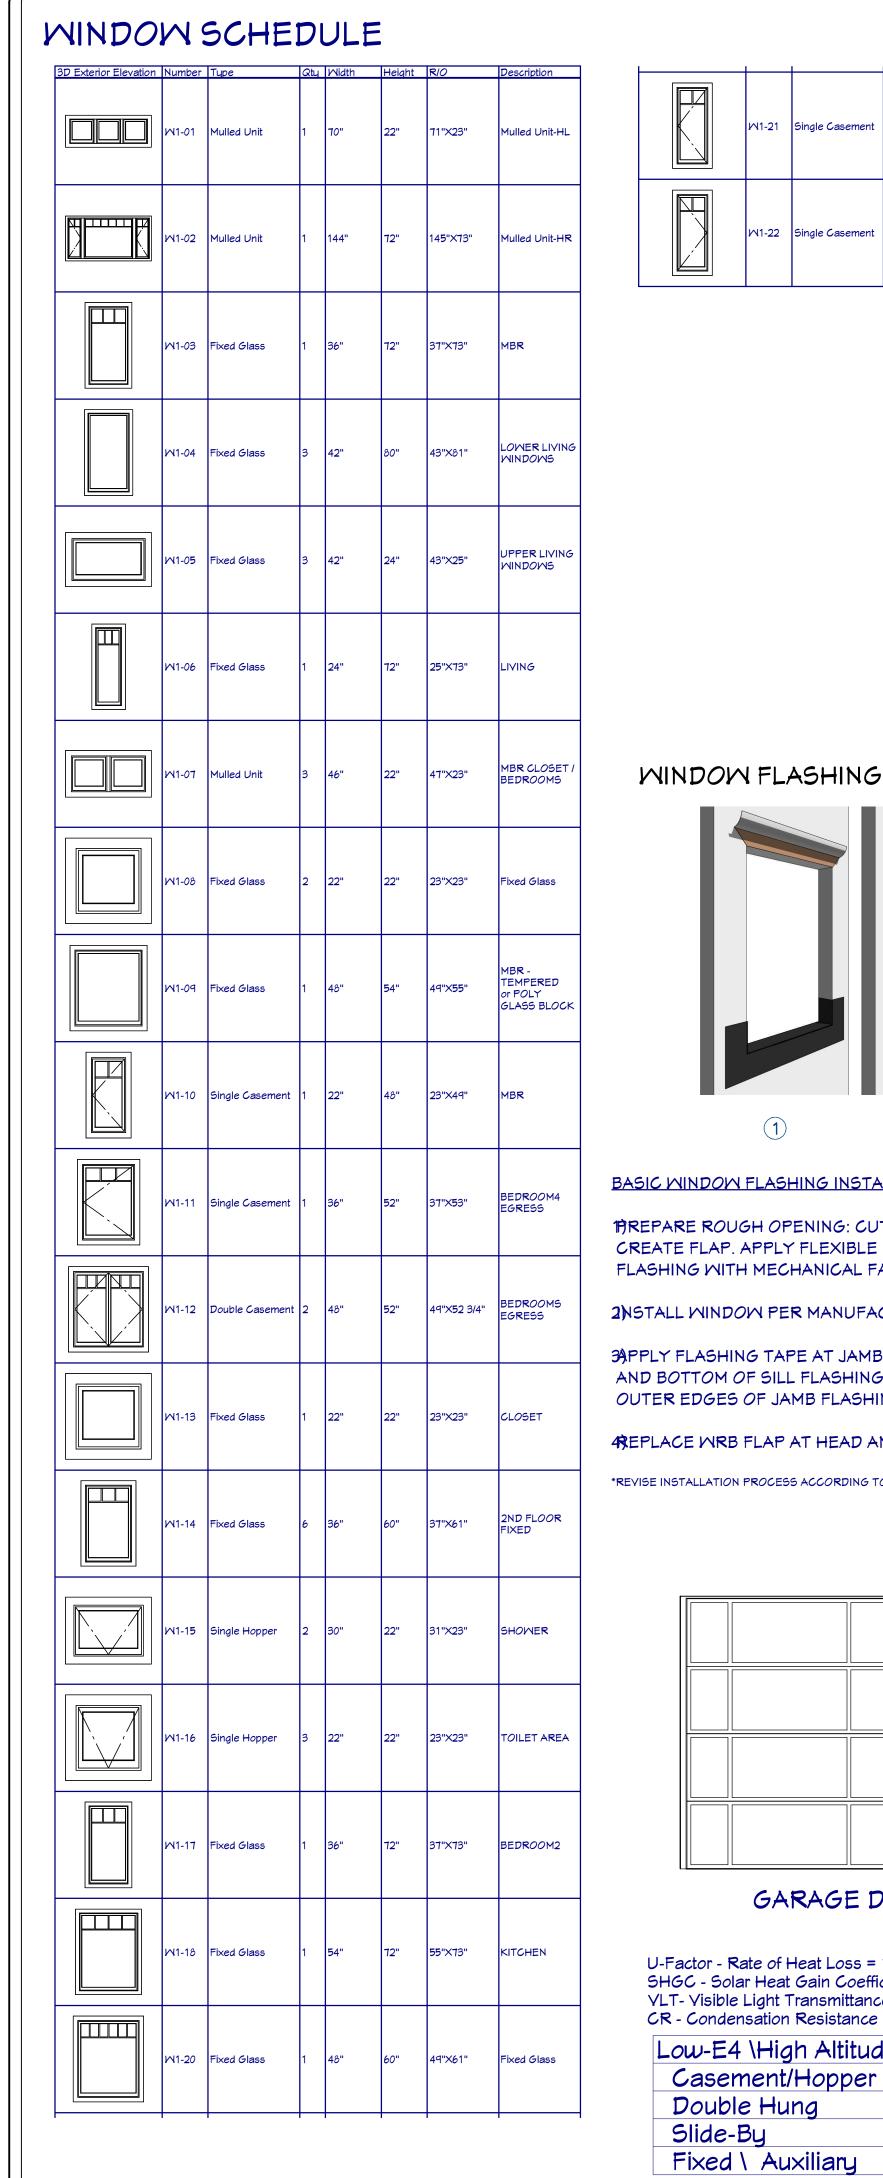

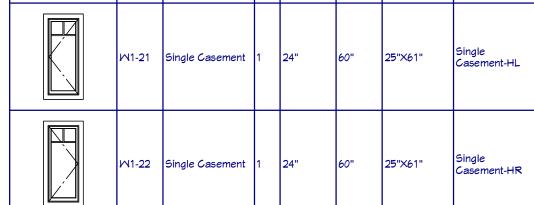

WINDOW NOTES:

- 1 WOOD WINDOWS WITH CLAD EXTERIOR SEE ENERGY RATINGS
- 2 INTERIOR WINDOW MATERIALS: STAINED WITH FACTORY FINISH, VERIFY WITH OWNER 3 MINDOM HARDMARE TO BE OMNER
- 4 MINDOM ROUGH OPENING: 1/2" FOR TOP/ BOTTOM & 1/2" FOR SIDES, UNO BY MFG


SELECTED AT TIME OF ORDER

- 5SEE WINDOW SCHEDULE CALLOUT FOR MINDOMS THAT USE A MOOD OR STEEL BEAM FOR THE HEADER
- 6 BEDROOM WINDOWS SILL FINISHED MUST BE WITHIN 44: OF THE FLOOR AND PROVIDE MINIMUM CLEAR OPENINGS OF 5.7 SQ. FEET WITH HEIGHT DIMENSION NOT LESS THAN 24" AND WIDTH DIMENSION NOT LESS THAN 20" -HRC R310.1-R310.1.4

DOOR NOTES:

- 1. MAIN FLOOR DOORS SHALL BE 96"; SECOND FLOOR DOORS 80", UNO
- 2. ALL DOORS SHALL BE SOLID CORE 1 3/4" THICK, UNO
- 3. INTERIOR DOORS SHALL BE STAINED -OR-PAINTED, VERIFY WITH OWNER
- 4. DOORS BETWEEN GARAGE AND LIVING AREA SHALL BE 1 3/4" TIGHT FITTING SOLID CORE DOORS WITH A RATING OF 60 MINUTES. DOOR SHALL BE SELF CLOSING
- 5. EXTERIOR EXIT DOORS SHALL BE 36" MIN. NET CLEAR DOOR WAY SHALL BE 32" MIN. DOOR SHALL BE OPENABLE FROM INSIDE
- 6. GARAGE DOORS TO BE SECTIONAL. OVERHEAD DOORS. IF GLASS, IT SHALL BE TEMPERED
- 7. ALL GLAZING WITHIN 18 IN. OF THE FLOOR AND/OR WITHIN 24 IN. OF ANY DOOR (REGARDLESS OF WALL PLANE) ARE TO HAVE SAFETY GLAZING
- 8. ALL TUB AND SHOWER ENCLOSURES ARE TO BE GLAZED WITH SAFETY GLASS
- 9. BARN DOORS, MEASURE TO FIT OPENING. ALL HARDWARE TO BE STAINLESS, UNO

DOOR SCHEDULE

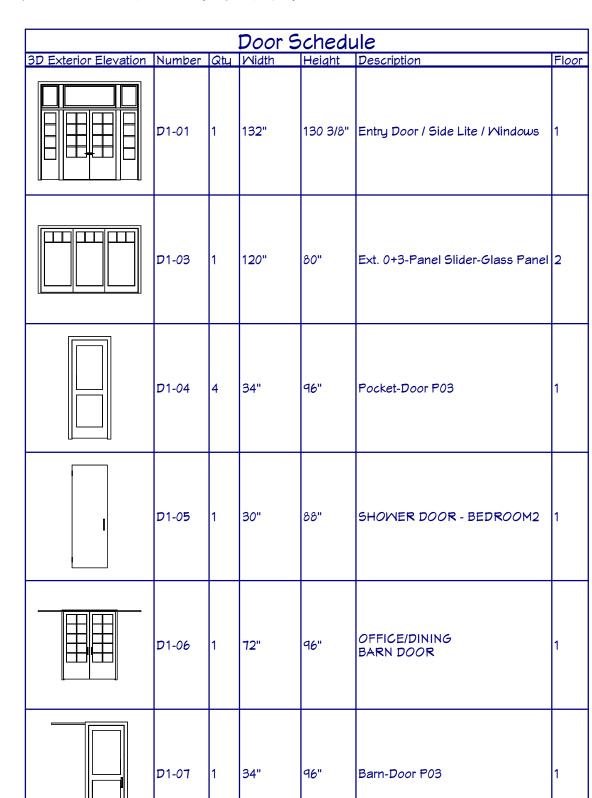

4 Dr. Bifold-Panel


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DRAWN BY: S.H.

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MINDOM FLASHING DETAIL



BASIC WINDOW FLASHING INSTALLATION*


TREPARE ROUGH OPENING: CUT STND. "I-CUT" IN THE MRB. CUT (2) 45° SLITS AT TOP TO CREATE FLAP. APPLY FLEXIBLE FLASHING AT SILL + 6" MIN. UP JAMBS. SECURE FLEXED EDGE OF FLASHING WITH MECHANICAL FASTENERS.

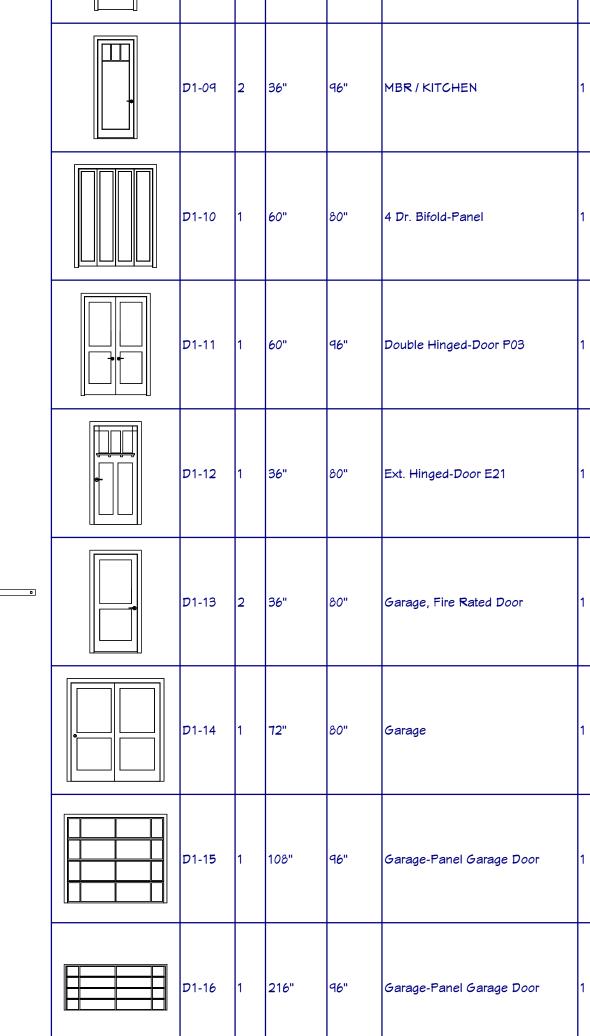2NSTALL WINDOW PER MANUFACTURER'S INSTRUCTIONS.

3)PPLY FLASHING TAPE AT JAMBS, EXTENDING 1" ABOVE AND BELOW WINDOW HEAD FLANGE AND BOTTOM OF SILL FLASHING, APPLY FLASHING TAPE ALONG HEAD, EXTENDING BEYOND OUTER EDGES OF JAMB FLASHING.


AREPLACE WRB FLAP AT HEAD AND TAPE REMAINING CUTS IN WRB

*REVISE INSTALLATION PROCESS ACCORDING TO WINDOW MANUFACTURER'S INSTRUCTIONS

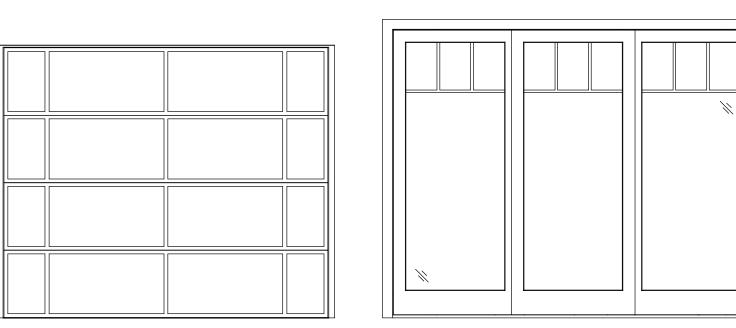

GARAGE DOOR

CASCADE SLIDING DOOR

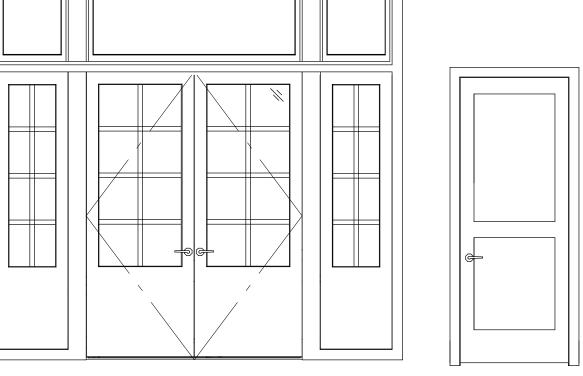

ENTRY DOOR UNIT

INTERIOR DOOR


BARN DOOR NOT LISTED IN SCHEDULE QUANTITY (2) RIGHT & LEFT

U-Factor - Rate of Heat Loss = 1/R SHGC - Solar Heat Gain Coefficient VLT- Visible Light Transmittance


MINDOM	FNFRGY	RATING
RAINDORA	ENERGI	KATING:


- Condensation Resistance YMMDOYMLINLING INATING	9	
ow-E4 \High Altitude Windows U-Factor SHGC	VLT	CR
Casement/Hopper 0.39 0.3	0.49	52
Double Hung 0.35 0.27	0.46	49
Slide-By 0.28	0.48	49
Fixed \ Auxiliary 0.32 0.32	0.54	51




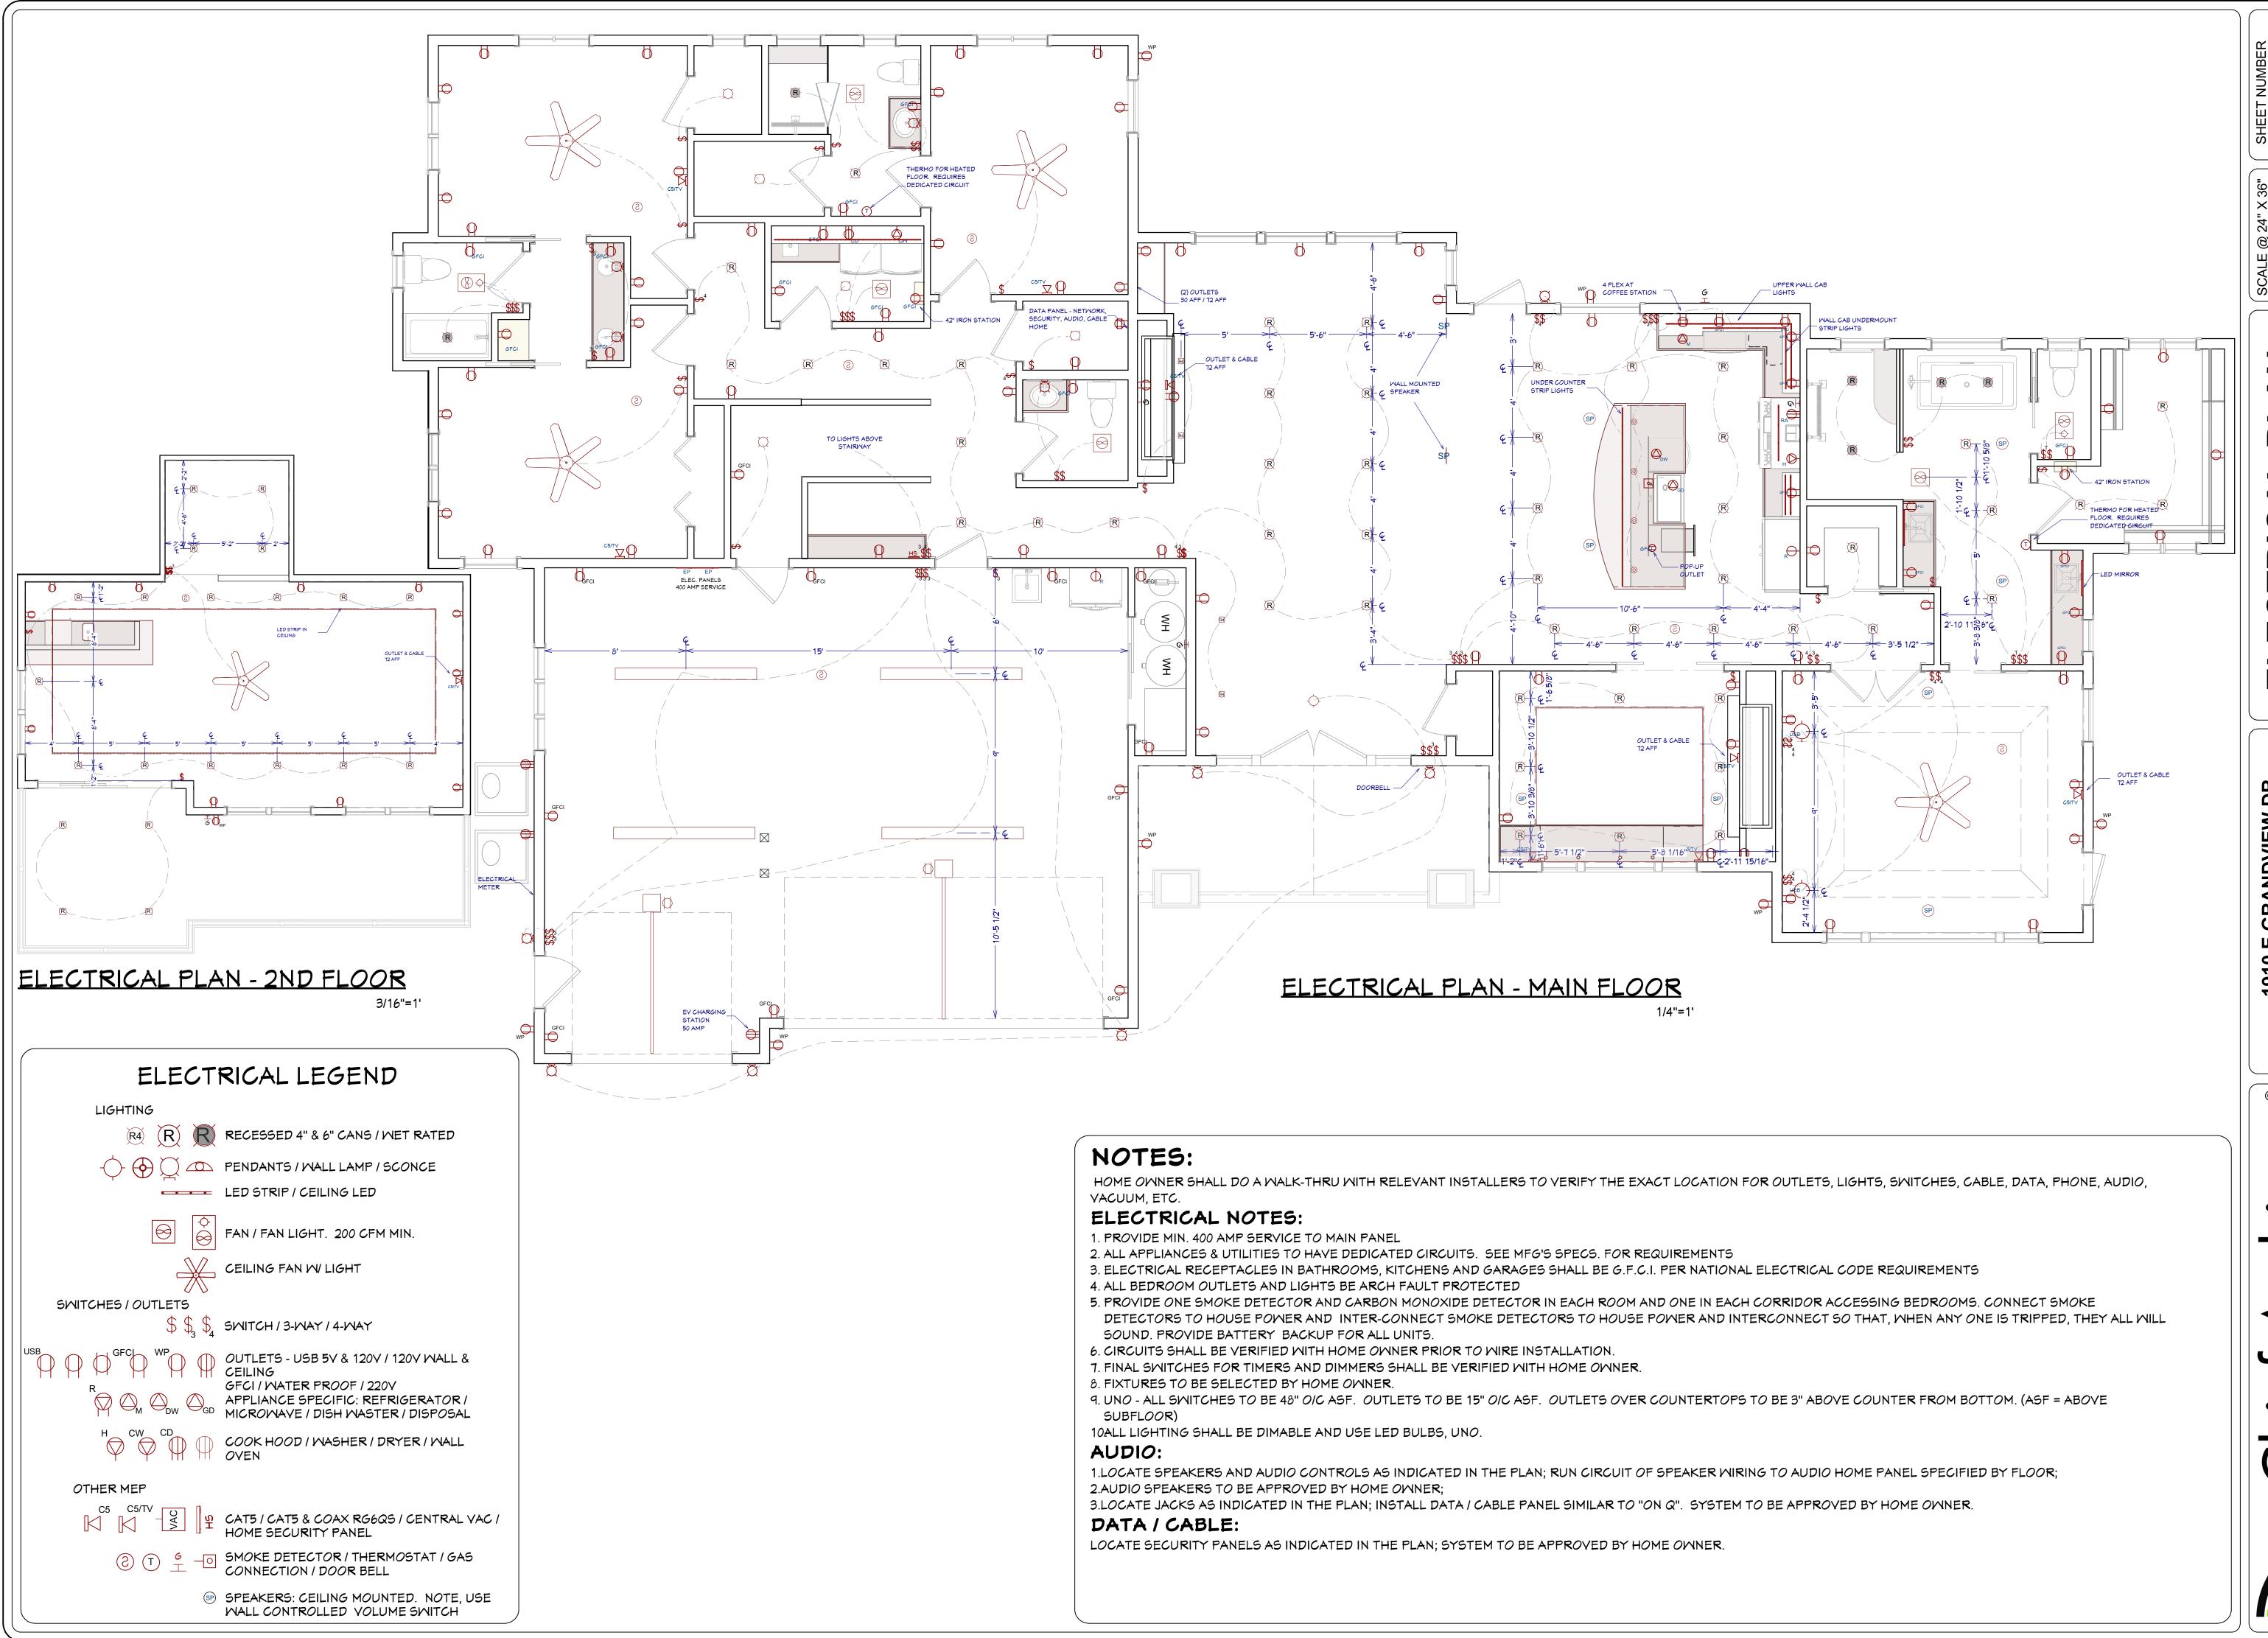


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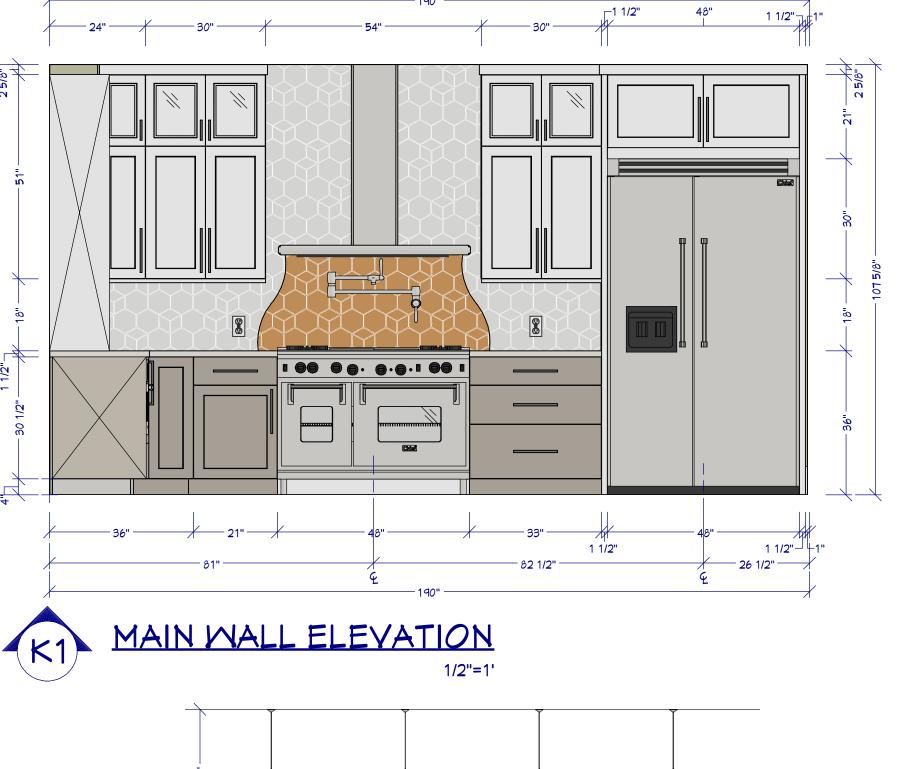


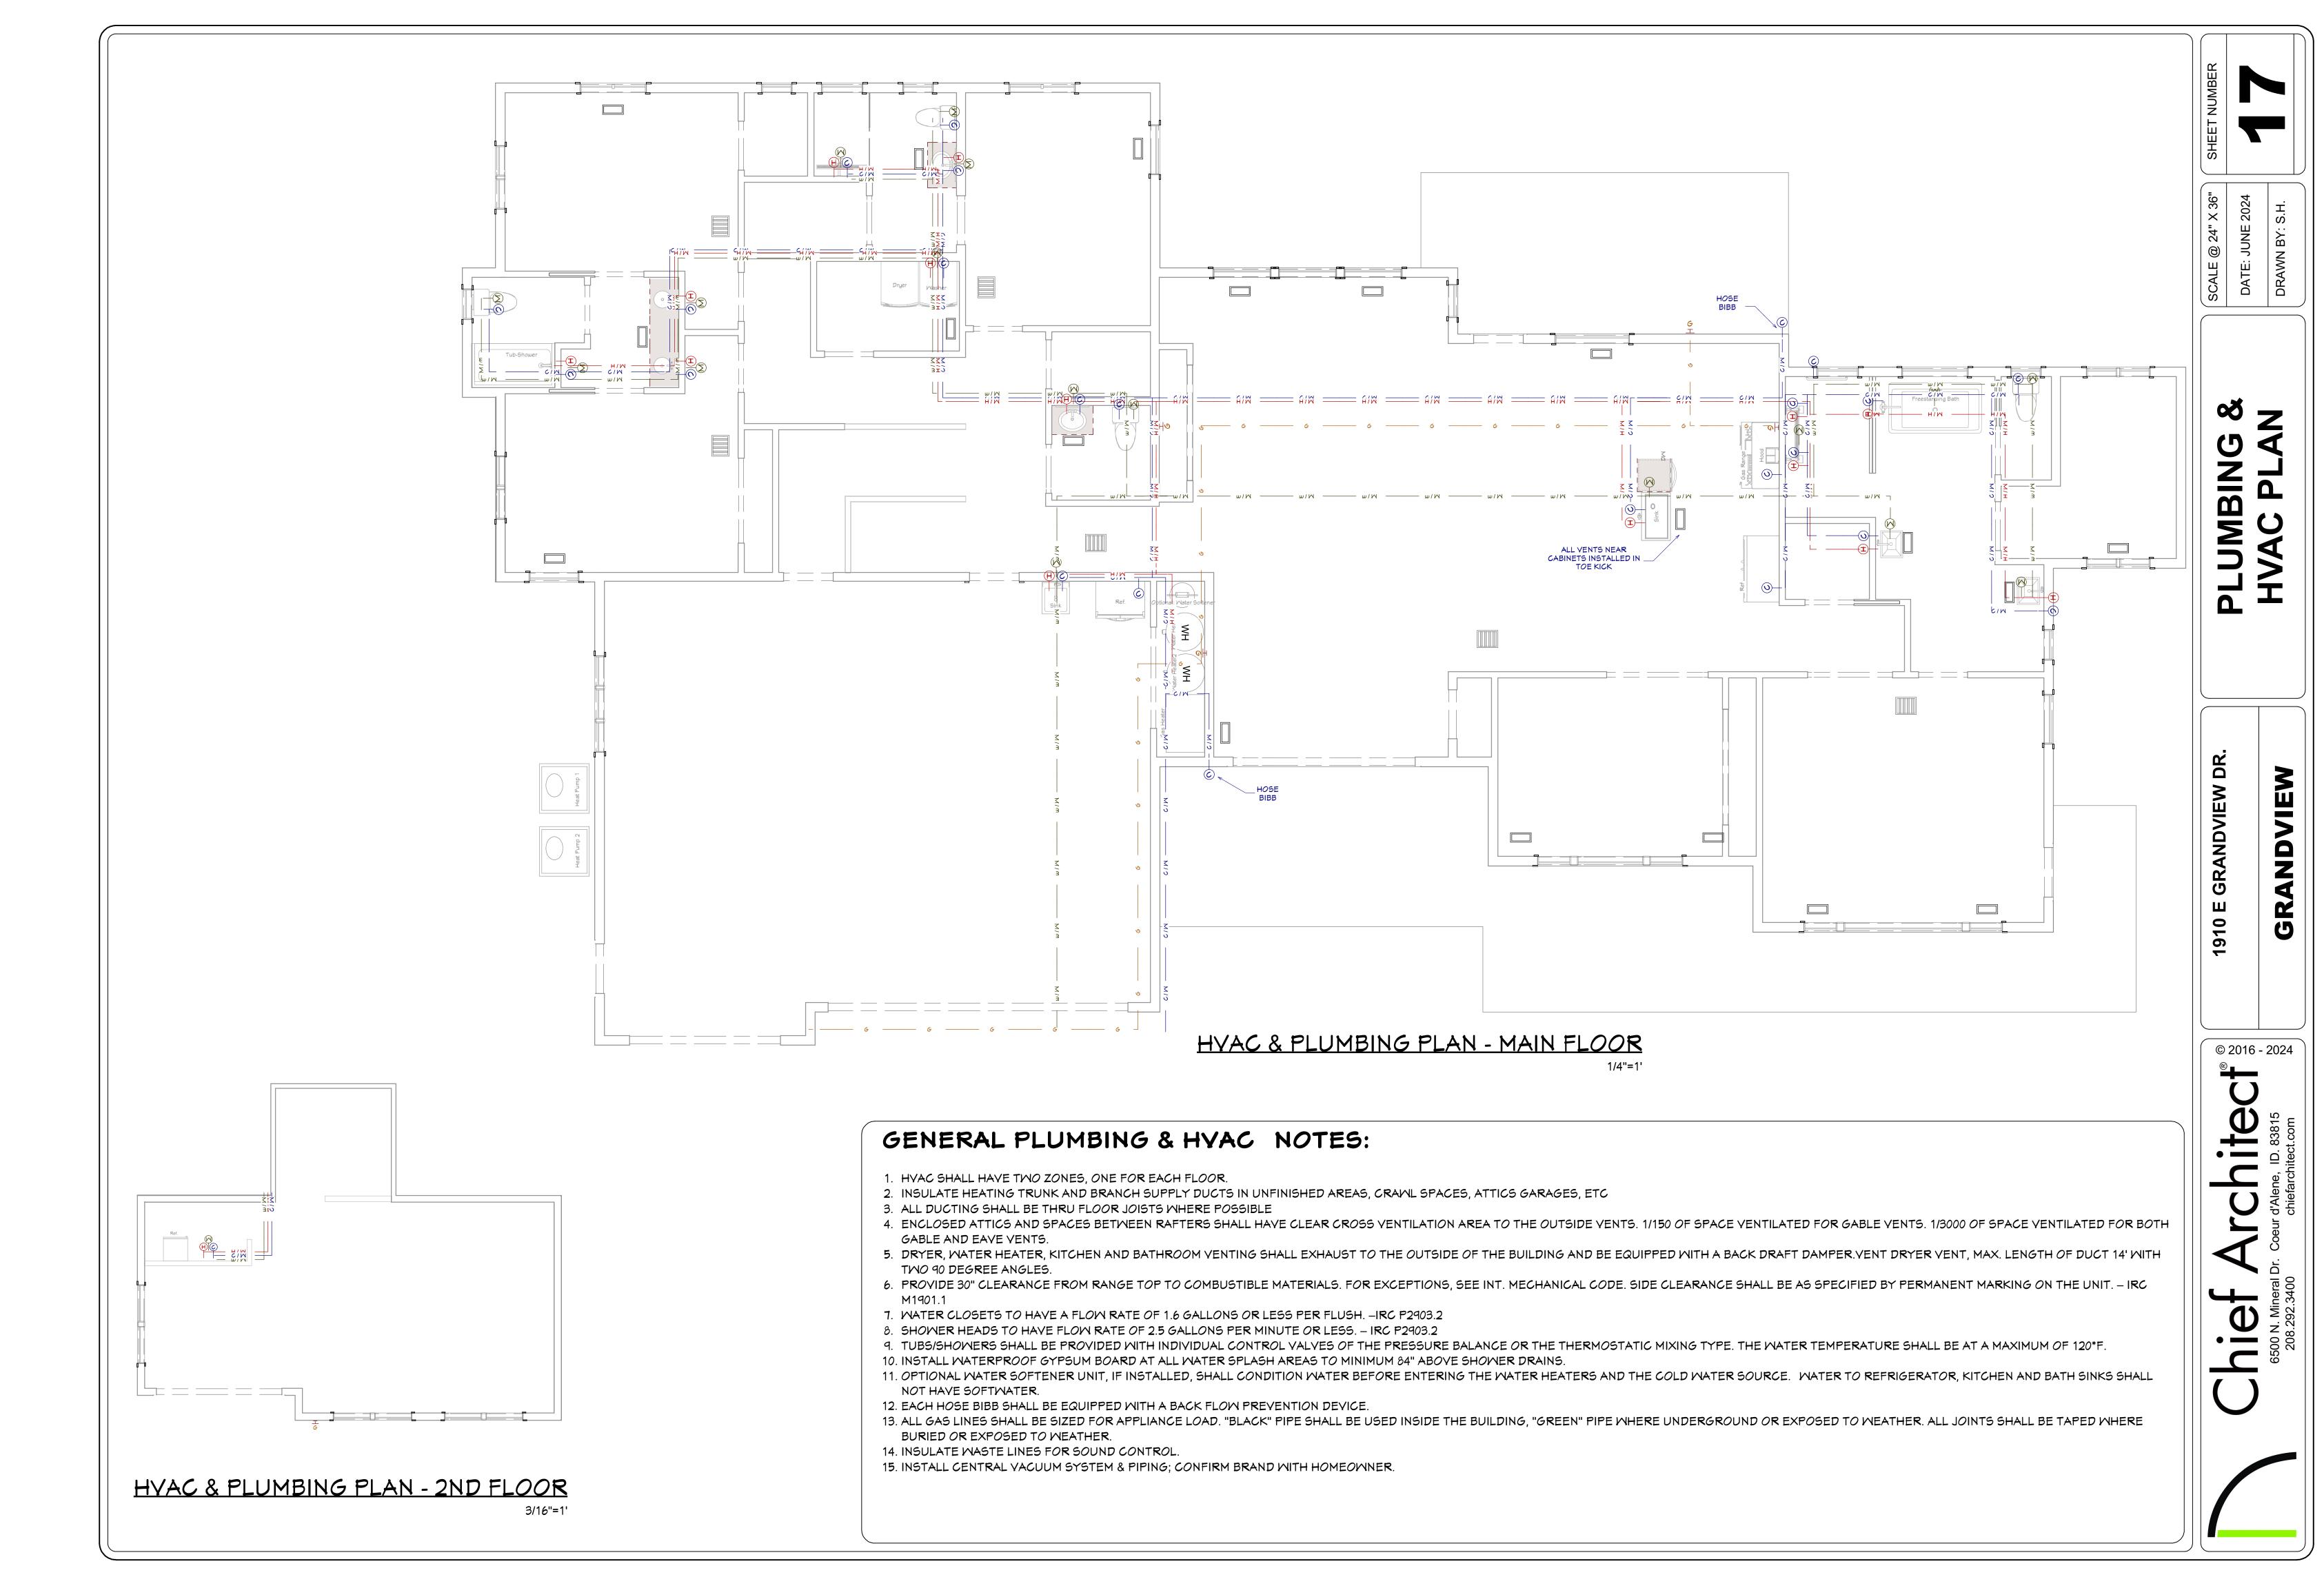


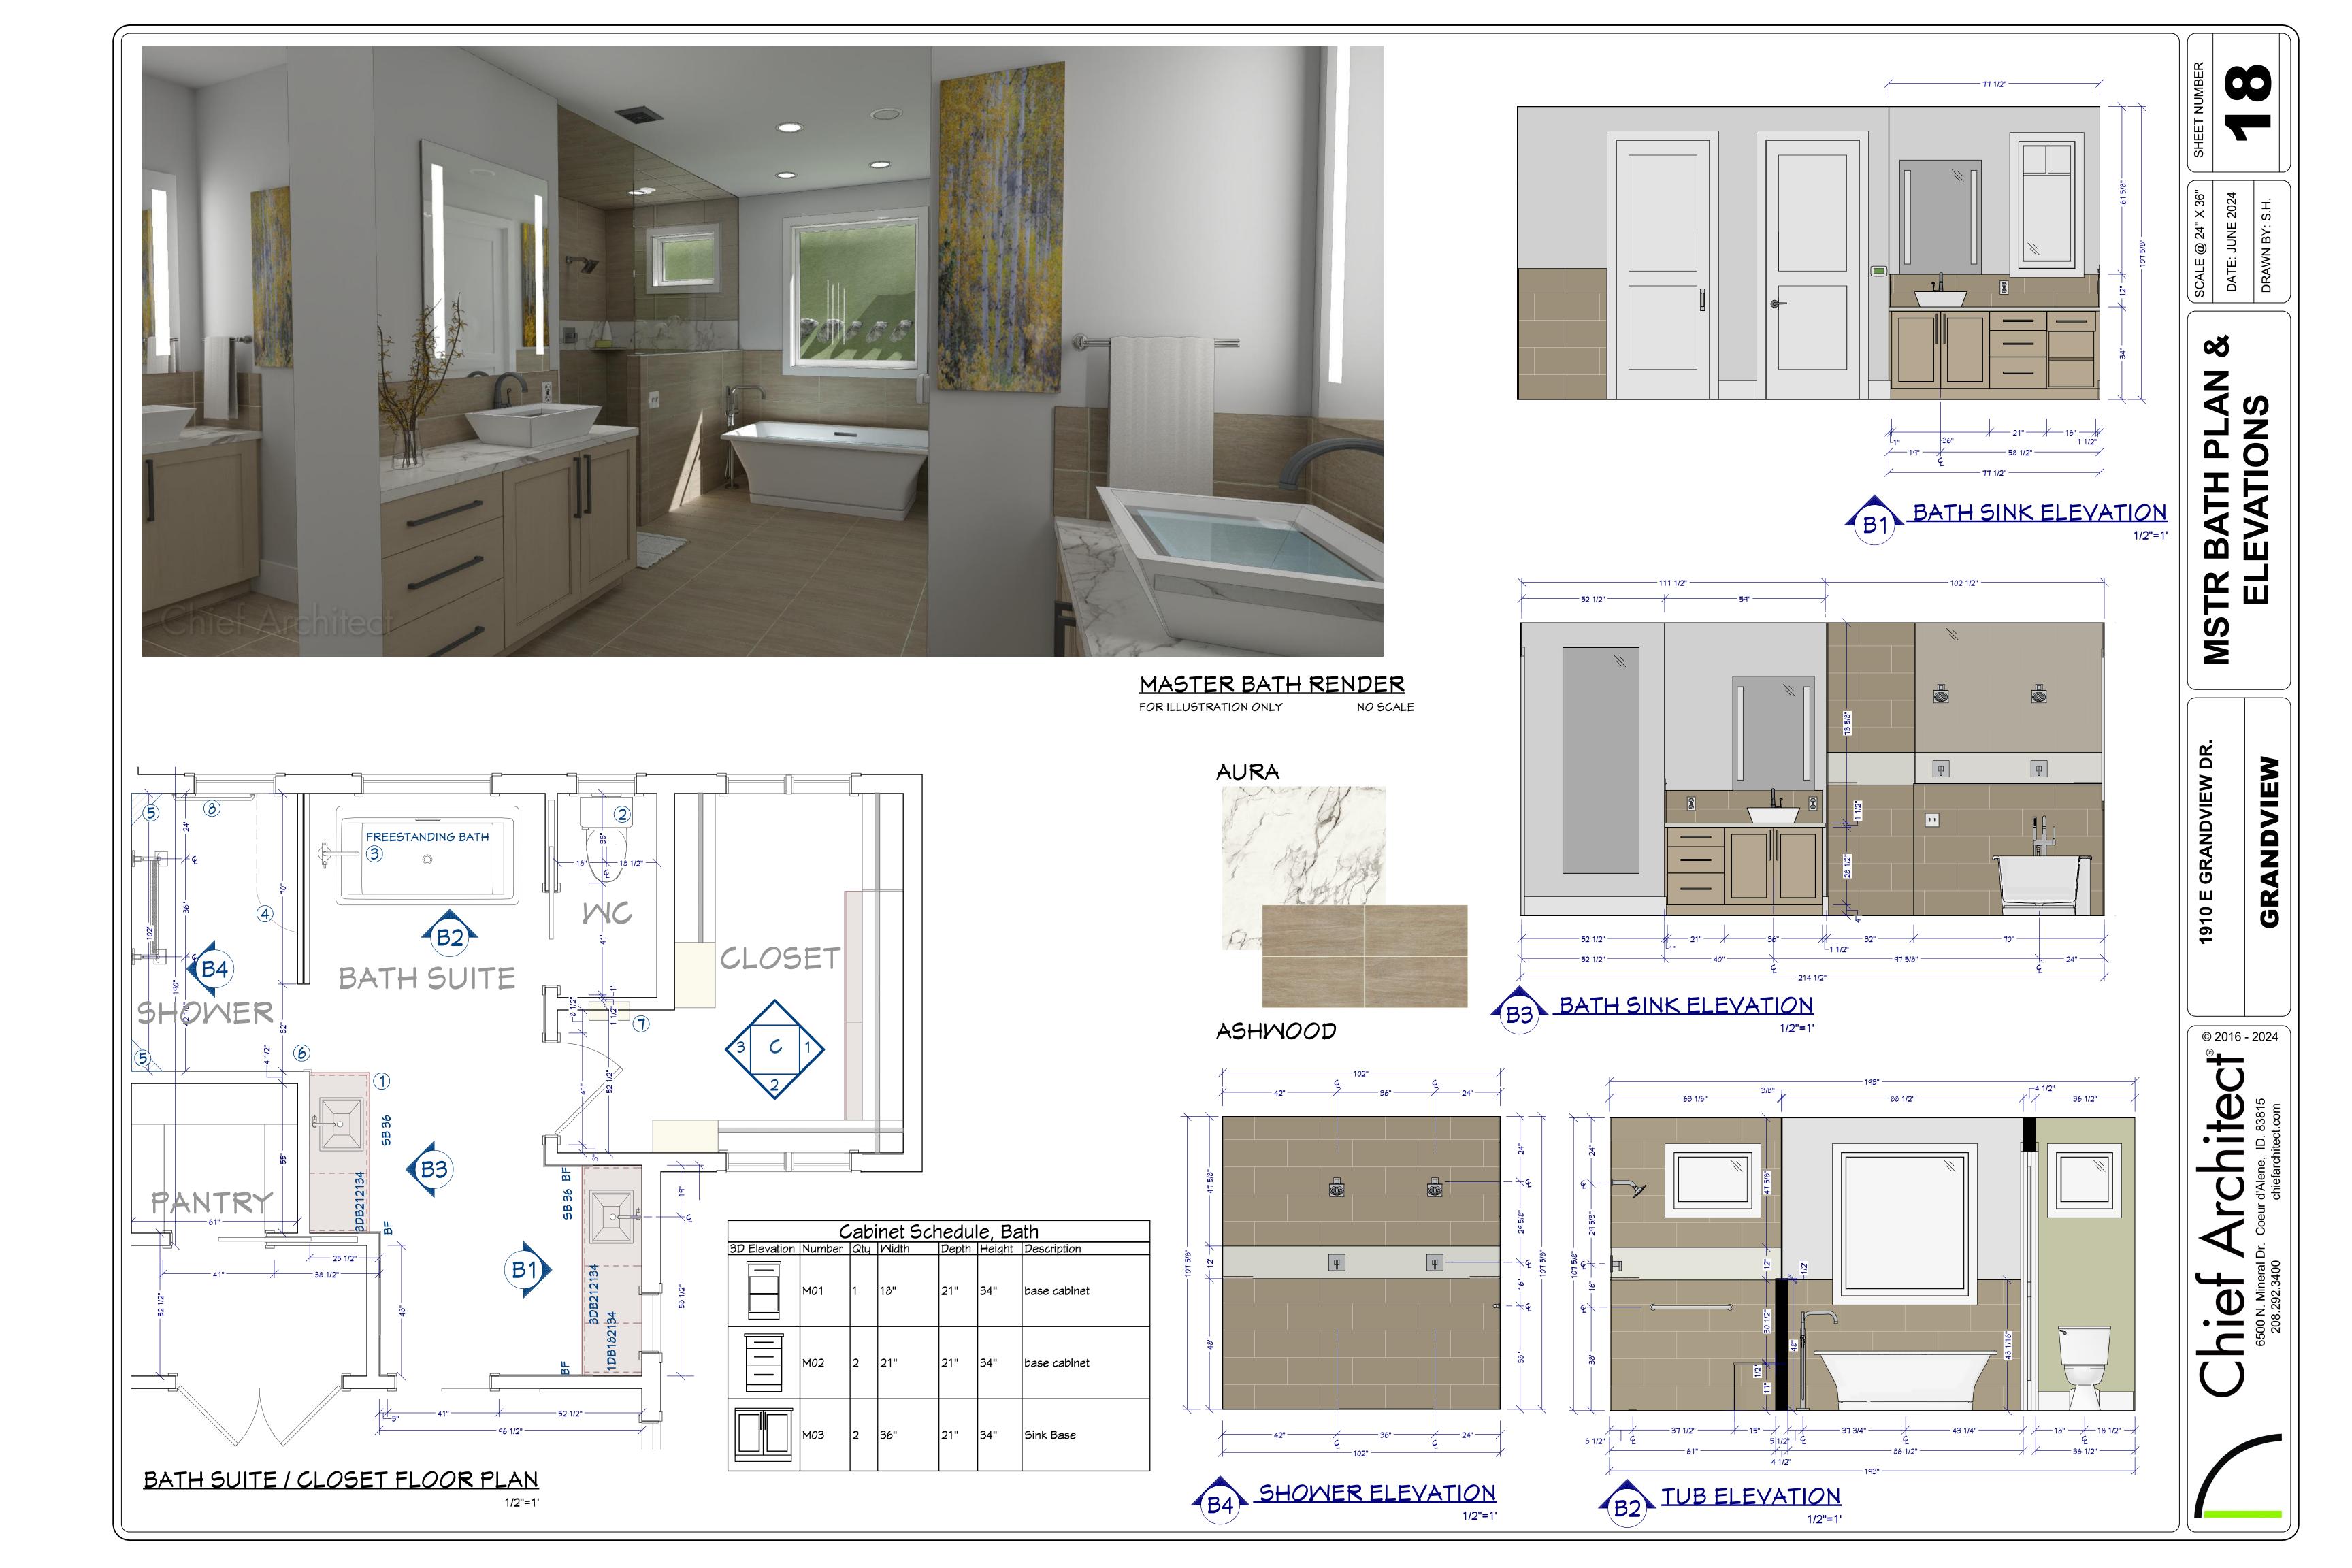

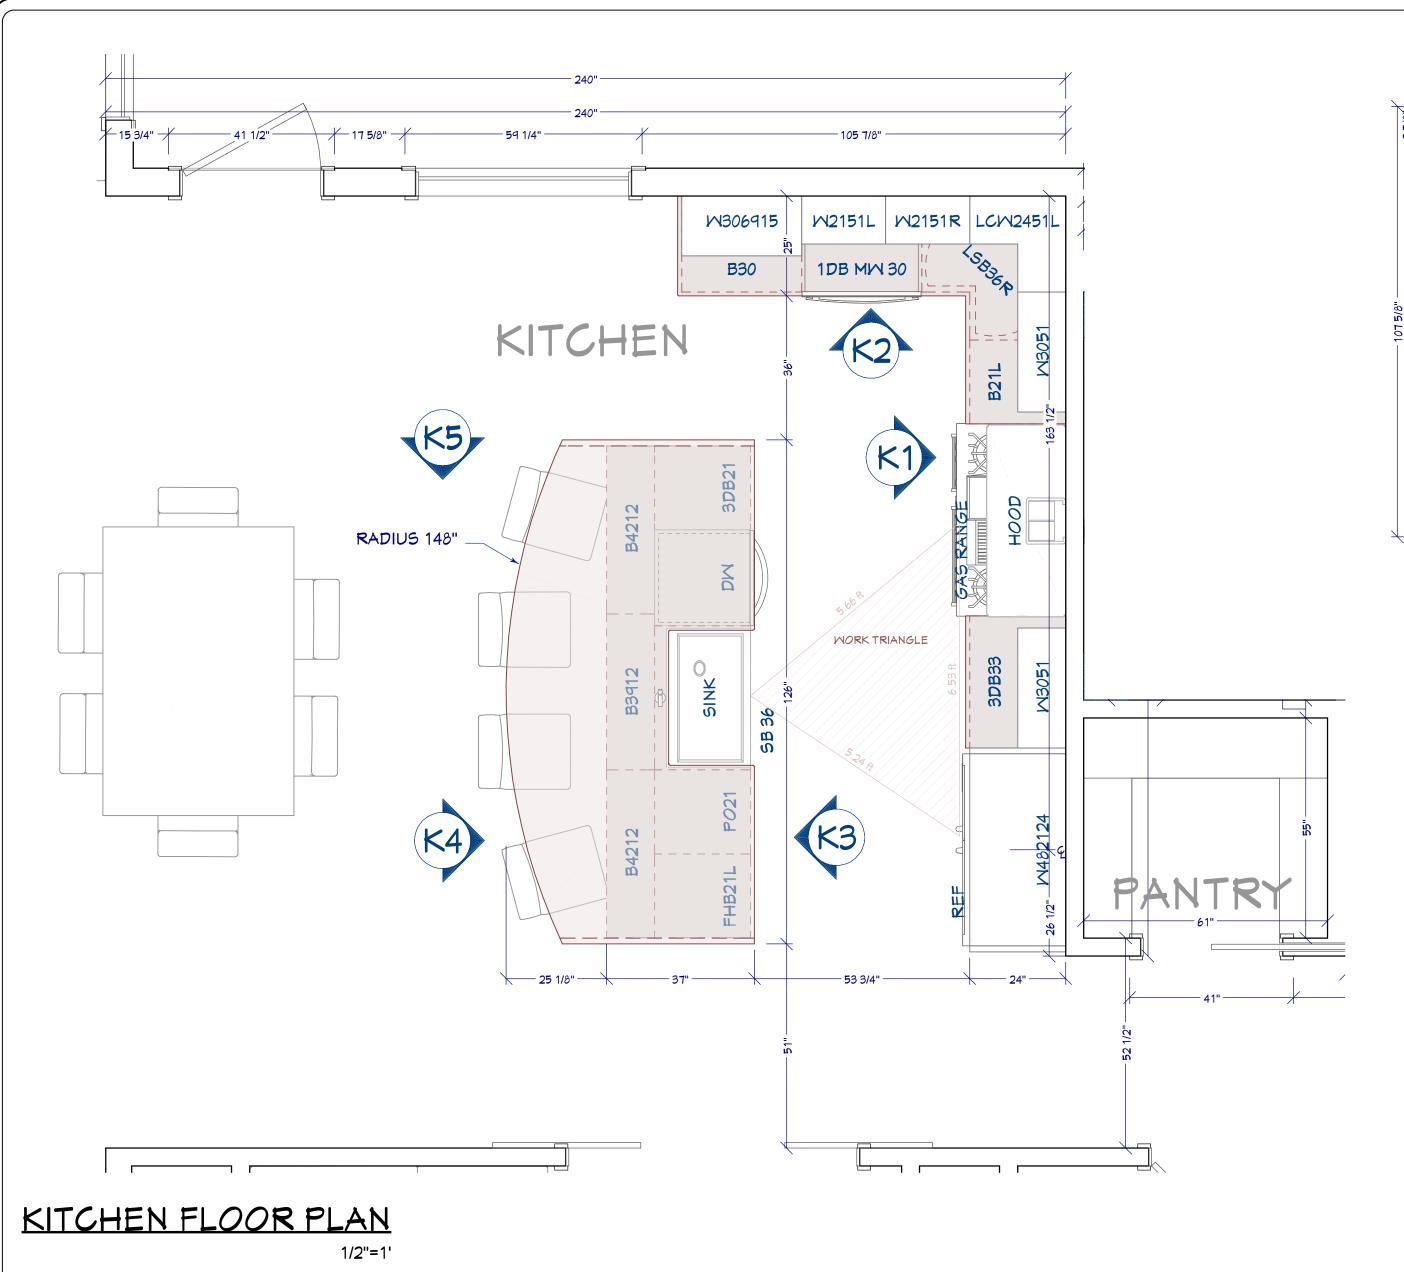
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NO SCALE

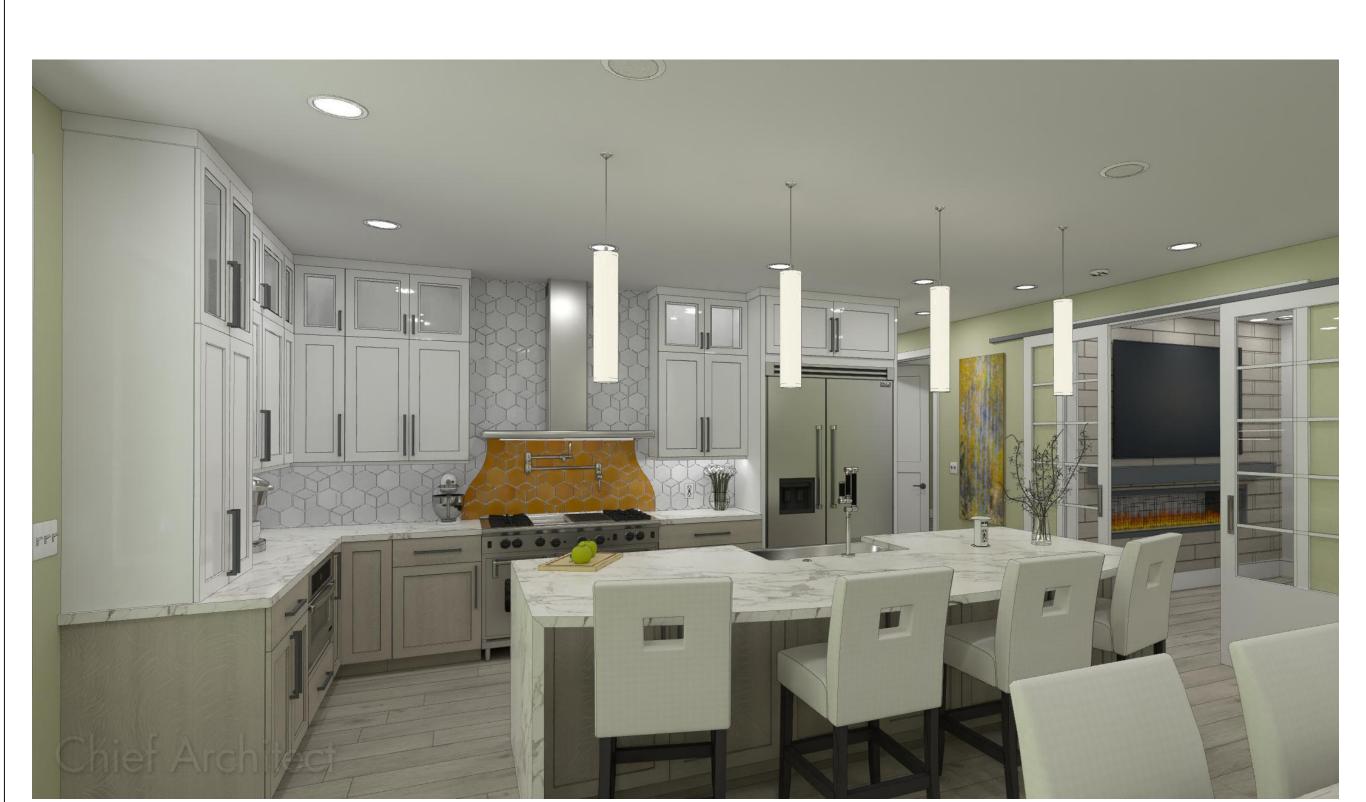



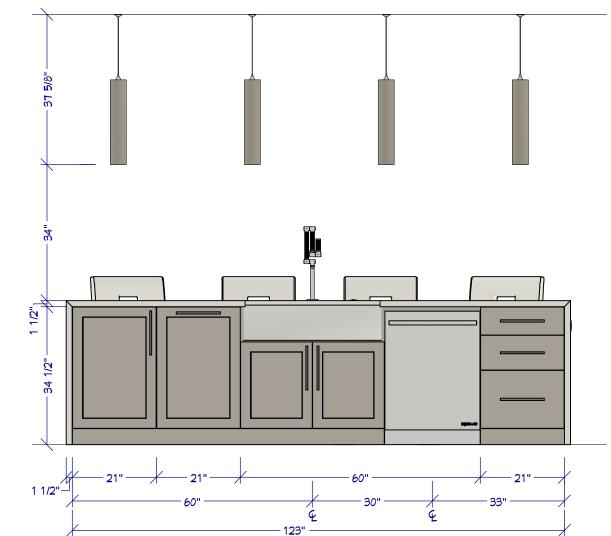

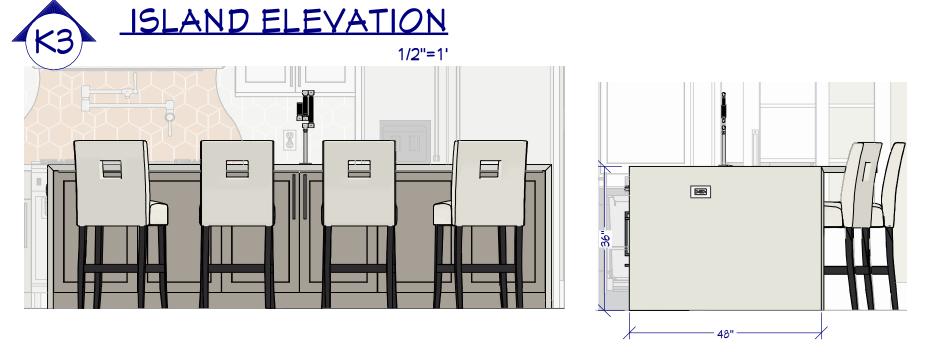

K4 ISLAND ELEVATION



KITCHEN & CABINET NOTES:

- 1 ALL CABINETS FRAMELESS, MAPLE OR ALDER
- 2 CONFIRM FINISH & STAIN/PAINT WITH CLIENT PRIOR TO ORDERING
- 3 CONFIRM DOOR & DRAWER STYLES WITH CLIENT PRIOR TO ORDERING
- 4 INSTALL HARDWARE ON SITE
- 5 INSTALL CROWN MOLDING ON SITE; CONFIRM PROFILE AND DIMENSION WITH HOME OWNER
- 6 CABINET SUPPLIER RESPONSIBLE FOR FINAL MEASUREMENTS & CABINET OPENINGS FOR APPLIANCES SPECIFICATIONS
- 7 ALL APPLIANCES TO BE ON DEDICATED CIRCUITS, UNO. REFER TO APPLIANCE SPECIFICATIONS FOR AMPI **YOLTAGE REQUIREMENTS**
- 8 USE MIN 6" DUCT FOR HOOD. CONFIRM HOOD IS 500 CFM MIN.
- 9 CONFIRM FINAL MATERIALS FOR BACKSPLASH AND COUNTERTOP WITH CLIENT PRIOR TO ORDERING
- 10 ALL DRAWERS TO BE TONGUE & GROOVE; GLIDES TO BE SOFT CLOSE
- 11 LED STRIP LIGHTS FOR WALL CABINETS AND UNDER ISLAND 12 COUNTER FABRICATION: CONFIRM ALL FIXTURE MEASUREMENTS AND CENTERLINES

96"	/
30" — 21" — 21" — 24" — 24"	/
	=======================================
	25/8"
	12 18
	18"—18"
	30 1/2"
30" 36" 51" 96"	4
K2 MALL ELEVATION 1/2"=1"	
1/2"=1'	

Cabinet Schedule, Kitchen

		Cabinel					
Elevation ————————————————————————————————————		Label 3DB21	<u>Qty</u> 1	21"	Depth 24"		Description base cabinet
	K02	3DB33	1	33"	24"	36"	base cabinet
	K03	B21L	1	21"	24"	36"	base cabinet
	K04	B30	1	30"	24"	36"	base cabinet
	K05	B3412	1	39"	12"	36"	base cabinet
	K06	B4212	2	42"	12"	36"	base cabinet
	K07	FHB21L	1	21"	24"	36"	base cabinet
	K08	M2151R	1	21"	12"	51"	wall cabinet
	K09	LSB36R	1	36"	36"	36"	corner base cabine
	K10	LCM2451L	1	24"	24"	51"	corner wall cabinet
	K11	P <i>O</i> 21	1	21"	24"	36"	base cabinet
	K12	SB 36	1	36"	24"	34 1/ 2"	Apron Sink Base
	K13	1DB MW 30	1	30"	24"	36"	base cabinet Microwave Drawer
	K14	M3051	2	30"	12"	51"	wall cabinet
	K15	M306915	1	30"	15"	69"	wall cabinet
	K16	M482124	1	48"	24"	21"	wall cabinet

KITCHEN RENDERING

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